MUNICIPAL PLANNING COMMISSION AGENDA SUMMER VILLAGE OF HALF MOON BAY SUMMER VILLAGES ADMINISTRATION OFFICE AUGUST 9, 2021 @ 9:00 A.M.

- A. CALL TO ORDER
- B. ADOPTION OF AGENDA
- C. DEVELOPMENT ITEMS
 - 1. 49 Lakeview Road
- D. ADJOURNMENT

Summer Village of Half Moon Bay – Municipal Planning Commission

August 9, 2021

Agenda Item

49 Lakeview Road (Lot 6, Block 4, Plan 3741MC)

Development Permit Application

Background:

An application was submitted on behalf of the registered owners for a new dwelling located on the property of 49 Lakeview Road (Lot 6, Block 4, Plan 3741MC) in the Summer Village of Half Moon Bay. This property is located in the R District (Residential). The proposed dwelling meets the front and rear yard setbacks, as well as one side yard setback and the height maximum. The proposed lot coverage would be 40% and under the maximum 45%.

Discussion:

This application is before MPC for the following reason:

• The proposed side yard setback of 1m (3.28ft.) does not meet the minimum 1.5m (4.92ft.) setback, therefore a variance of 0.5m (1.64ft.) is required.

With a side yard of 1m (3.28ft.), a projection is to not exceed one-half of the minimum side yard requirement. Half of the side yard would be .5m (1.64ft.), with the projection (eave) being 0.6m (2ft.), the eave projection would be over by 0.1m (0.3ft.) The fireplace projects 0.5m (1.64ft.) and would be compliant with the projection regulation.

Recommendation:

"The Development Authority may approve an application for Development Permit even though the proposed development does not comply with this bylaw or is a nonconforming building if, in the opinion of the Development Authority;

- (a) The proposed development would not:
 - (i) Unduly interfere with the amenities of the neighbourhood, or
 - (ii) Materially interfere with or affect the use, enjoyment or value of neighbouring parcels of land."

As this is a small variance of 0.5m, no other variances are being requested and no feedback has been received from neighbouring properties, administration feels that the proposed development would not unduly interfere with the amenities of the neighbourhood or materially interfere with or affect the use, enjoyment, or value of neighbouring parcels. After reviewing all relevant planning documents, it is the recommendation of administration to approve the application for the dwelling with the side yard variance requested.

Conditions:

If approved, Administration would recommend the following conditions:

- Electrical power from the property line to any buildings situated on this parcel to be constructed underground.
- The height of the dwelling shall not exceed 10m (32.81ft.) in building height measured from grade.
- Completions Deposit of \$5,000.00
- Footing check survey required from an Alberta Land Surveyor at the time of footings prior to continuation of construction.
- Final as build real property report from an Alberta Land Surveyor at completion of landscaping that includes parcel coverage.
- All parcels shall be graded to ensure that storm water is directed to a drainage ditch without crossing adjacent land, except as permitted by the Development Authority. All maintenance and upkeep shall be the responsibly of the property owner. A lot grade certificate may be required at completion to ensure that proper drainage on the property exists.
- Landscaping to be completed according to the landscaping plan.

Authorities

The MPC may:

- Grant a variance to reduce the requirements of any use of the LUB and that use will be deemed to comply with LUB.
- Approve application even though the proposed development does not comply or is a nonconforming building if:
 - o It would not unduly interfere with the amenities of the neighborhood, or o Materially interfere with or affect the use, enjoyment, or value of neighboring parcels of land, And
 - o It conforms with the use prescribed for that land or building in the bylaw.
- Consider a Variance only where warranted by the merits or the proposed development and in response to irregular lot lines, parcel shapes or site characteristics which create difficulties in siting structures within the required setback or in meeting the usual bylaw requirements, except there shall be no variance for Parcel Coverage or Building Height.

Decision:

In order to retain transparency of the Commission, Administration recommends one of the following:

- 1. Approve the application with or without conditions (Section 642 of the MGA), or
- 2. Deny the application stating reasons why (Section 642(4) of the MGA).

LETTER OF INTENT

The purpose of this letter is to explain, **in detail**, the intention for the property (new development, tenant improvements, bylaw variances, renovations/alterations, etc.)

Name of Appli	cant:		
Site Address:	49	Lakeview Road, Ha	alf Moon Bay
Type of Applic	ation:	Building PermitDevelopment Permit	Home OccupationOccupancy Permit
I/We intend	d to	Demolish the existi	ng cabin, and build a new
cabin ir	nclud	ding covered deck.	
As per	the p	plot plan we are wa	anting to have a relaxation
on the	Righ	it side yard from 1.	5m to 1.0m. This will keep
the nev	v cal	bin in line with the	existing carriage house,
(garage	e). Tł	ne side wall will cla	dded with fibre cement siding.
		×	
-			
June 1, 2021			Signature of Applicant
Date			Signature of Applicant

49 Lakeview Road

Half Moon Bay, Sylvan Lake

The original cabin is to be demolished and a new cabin to be built in its place. The Carriage House was built in 2020, and this will remain, as completed.

TREE REMOVAL:

Trees to the removed are located on the north side of the existing cabin.



Their removal is required for the demolition of the existing cabin. The trees along the property line will remain.

Demolition Plan

Asbestos test has been completed and report is included with this plan.

Alberta One call will be completed prior to demolition.

Utilities – the primary lines have all been connected to the new Carriage house, so the secondary shut off to the existing cabin will be shut off prior to demolition.


The dust and debris with remain with in the lot, and the trade partners will be limited at time of the demolition. Proximity to the water will always be taken into consideration, and no debris will enter the water. Only professional trades will be used for the demolition and the reclamation of the property.


All environmental considerations will be always maintained.

The work will only commence during 7am – 7pm.

Public Land

Any public land impacted during the demolition or re-build will be reinstated to their original condition.

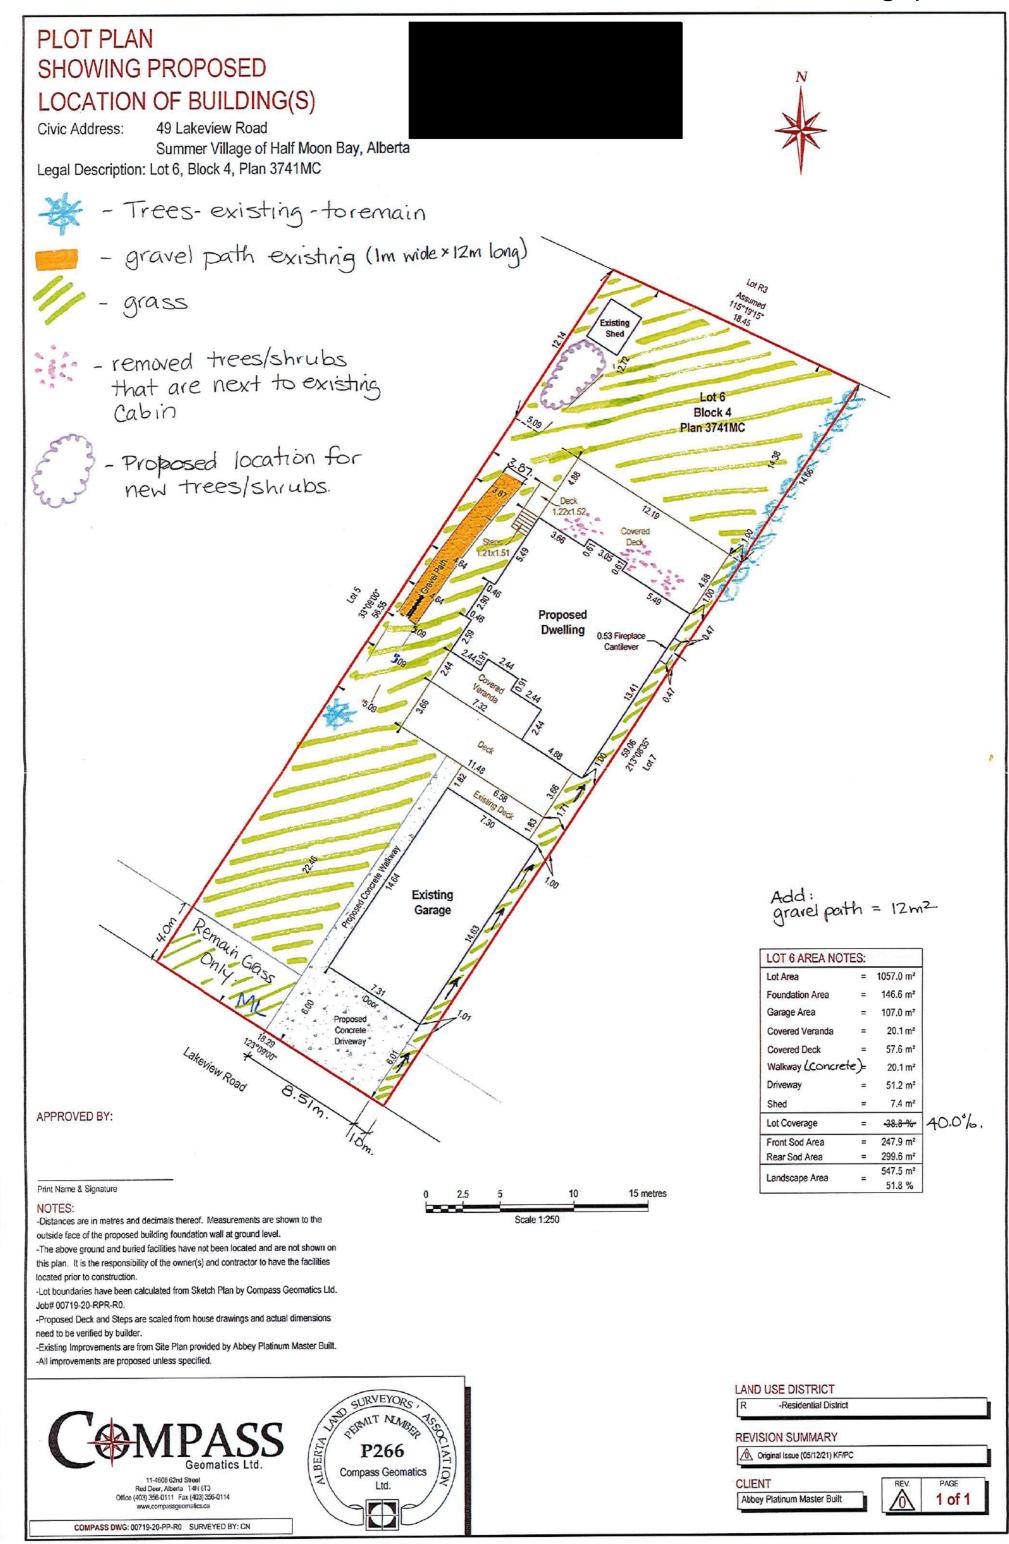

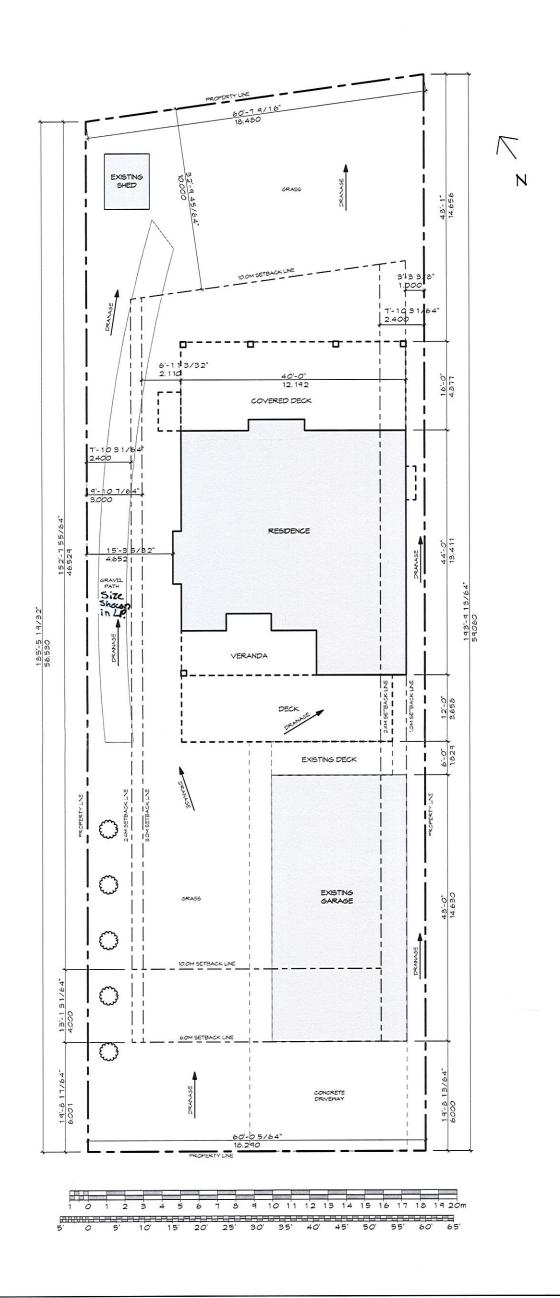


SITE PLAN



NOTE: FINAL BUILDING & SPEC MAY NOT BE EXACTLY AS SHOWN

THESE DRAWINGS MAY NOT BE USED OR DUPLICATED WITHOUT THE PERMISSION OF KD RESIDENTIAL DESIGN INC.

MANDER INN

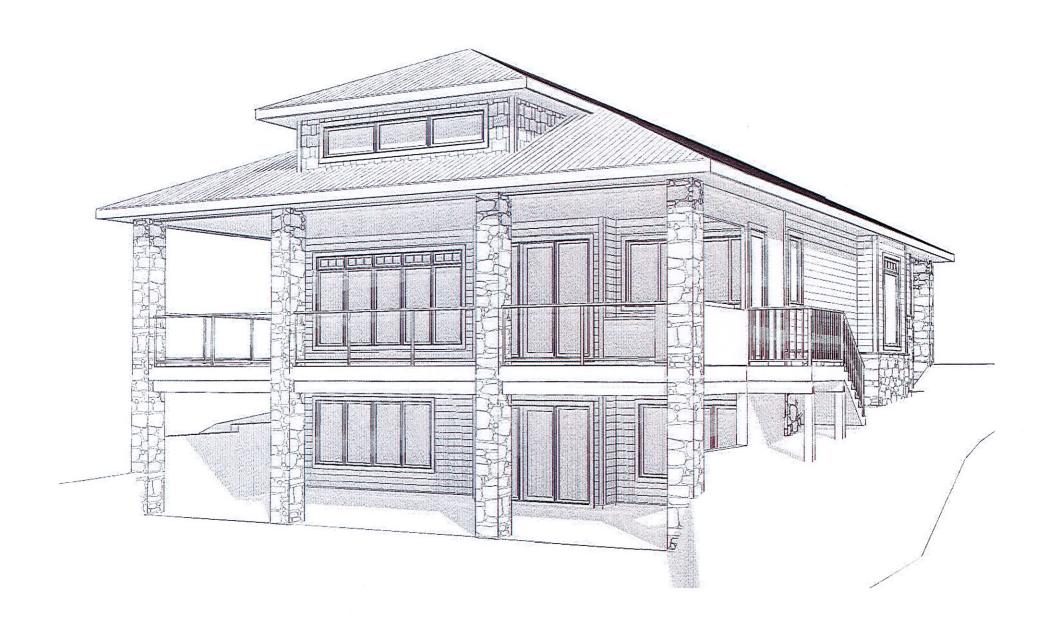



LIST OF DRAWINGS


- AO1 TITLE PAGE
- A02 FOUNDATION PLAN
- A03 LOWER FLOOR PLAN
- A04 MAIN FLOOR PLAN
- A05 ROOFPLAN
- A06 ELEVATIONS
- A07 ELEVATIONS
- A08 ELEVATIONS
- A09 ELEVATIONS
- A 10 BUILDING SECTIONS
- A 1 1 BUILDING SECTIONS
- A12 CNST DTLS / NOTES / LEGENDS
- A13 SITE PLAN
- EO1 MAIN FLOOR ELECTRICAL
- EO2 LOWER FLOOR ELECTRICAL


ALL SPECIFICATIONS FOR THE NBC 2019 (AE)
9.36. ENERGY CODE TO BE SUPPLIED BY
OTHERS


DRAWINGS TO BE REVIEWED & APPROVED BY
THE LOCAL MUNICIPALITY OR PERMITTING
AUTHORITIES CIVIC ADDRESS CLIMATE ZONE: BUILDING AREA AIRTIGHTNESS LEGAL ADDRESS: 49 LAKEVEM RD, SV OF HALF MOON BAY, AB LOT: 6, BLOCK: 4, PLAN: 3741 MC TA 224 SQ M 2.5 DRAFTED BY: PROJECT NAME: PROJECT NUMBER: SCALE: CLIENT CONTACT INFO: MAIN FLOOR: 1589 SF DEV LOWER FLOOR: 1205 SF MANDER INN AP-2021-02 TOTAL LOWER FLOOR: 1488 SF TOTAL DEVELOPED: 2794 SF KAREN RICHINSKI CELL: 403,396,0354 EMAIL: KAREN@KDRD.CA WEB: WWW.KDRD.CA SHEET TITLE: DATE: Abbey Platinum KD RESIDENTIAL AO1 Master Built TITLE PAGE 29-04-2021

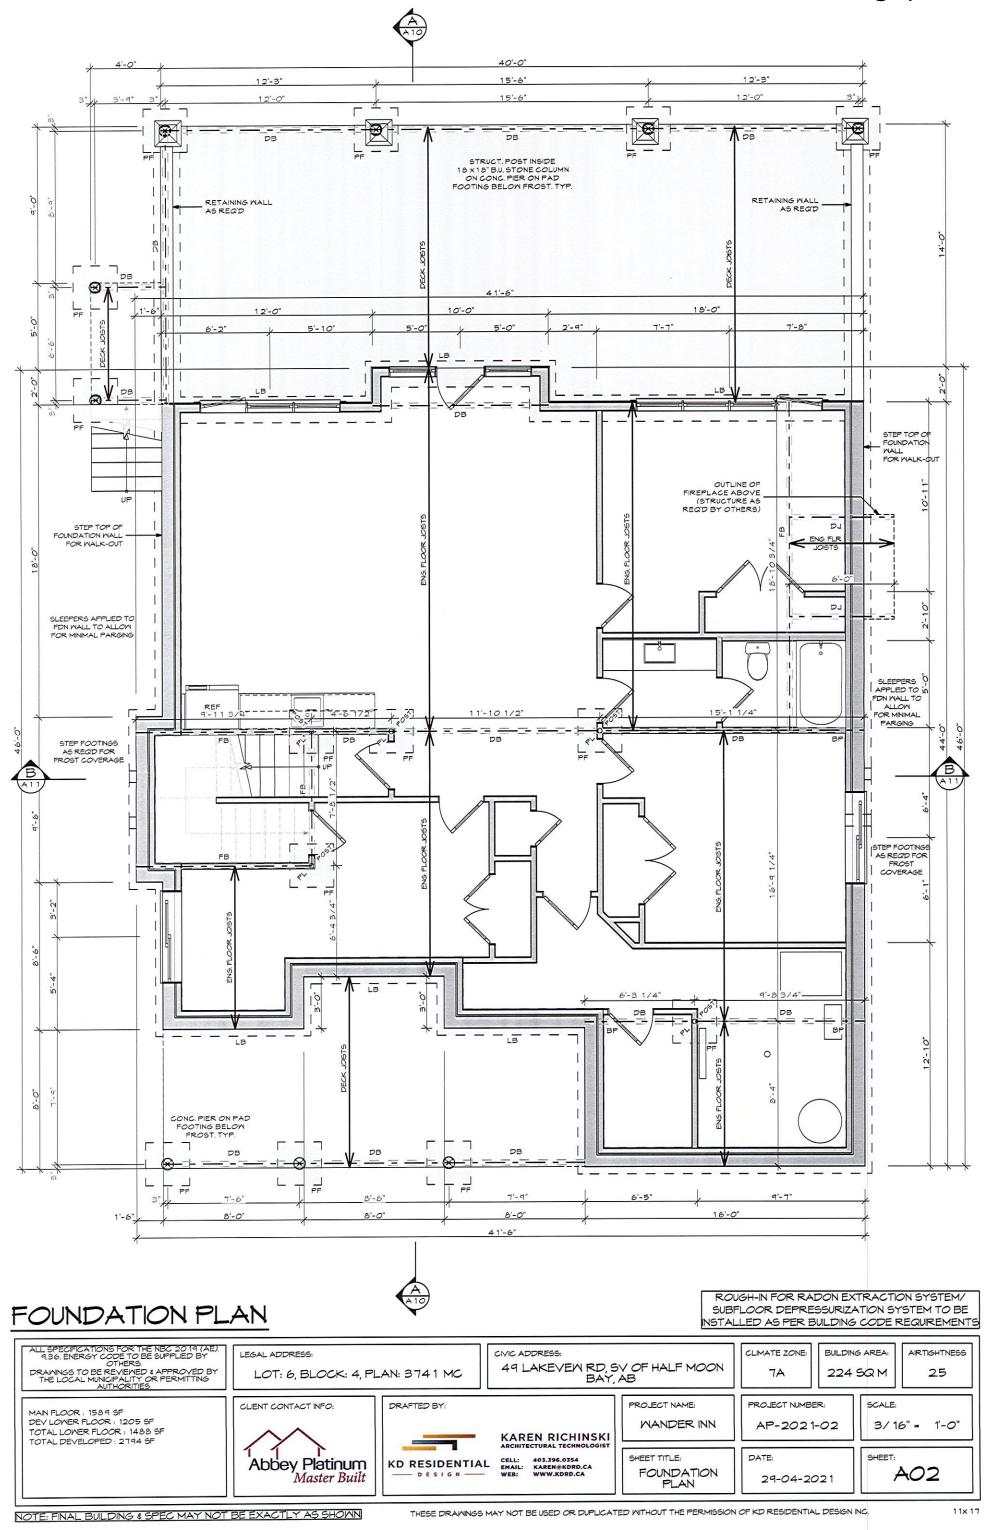

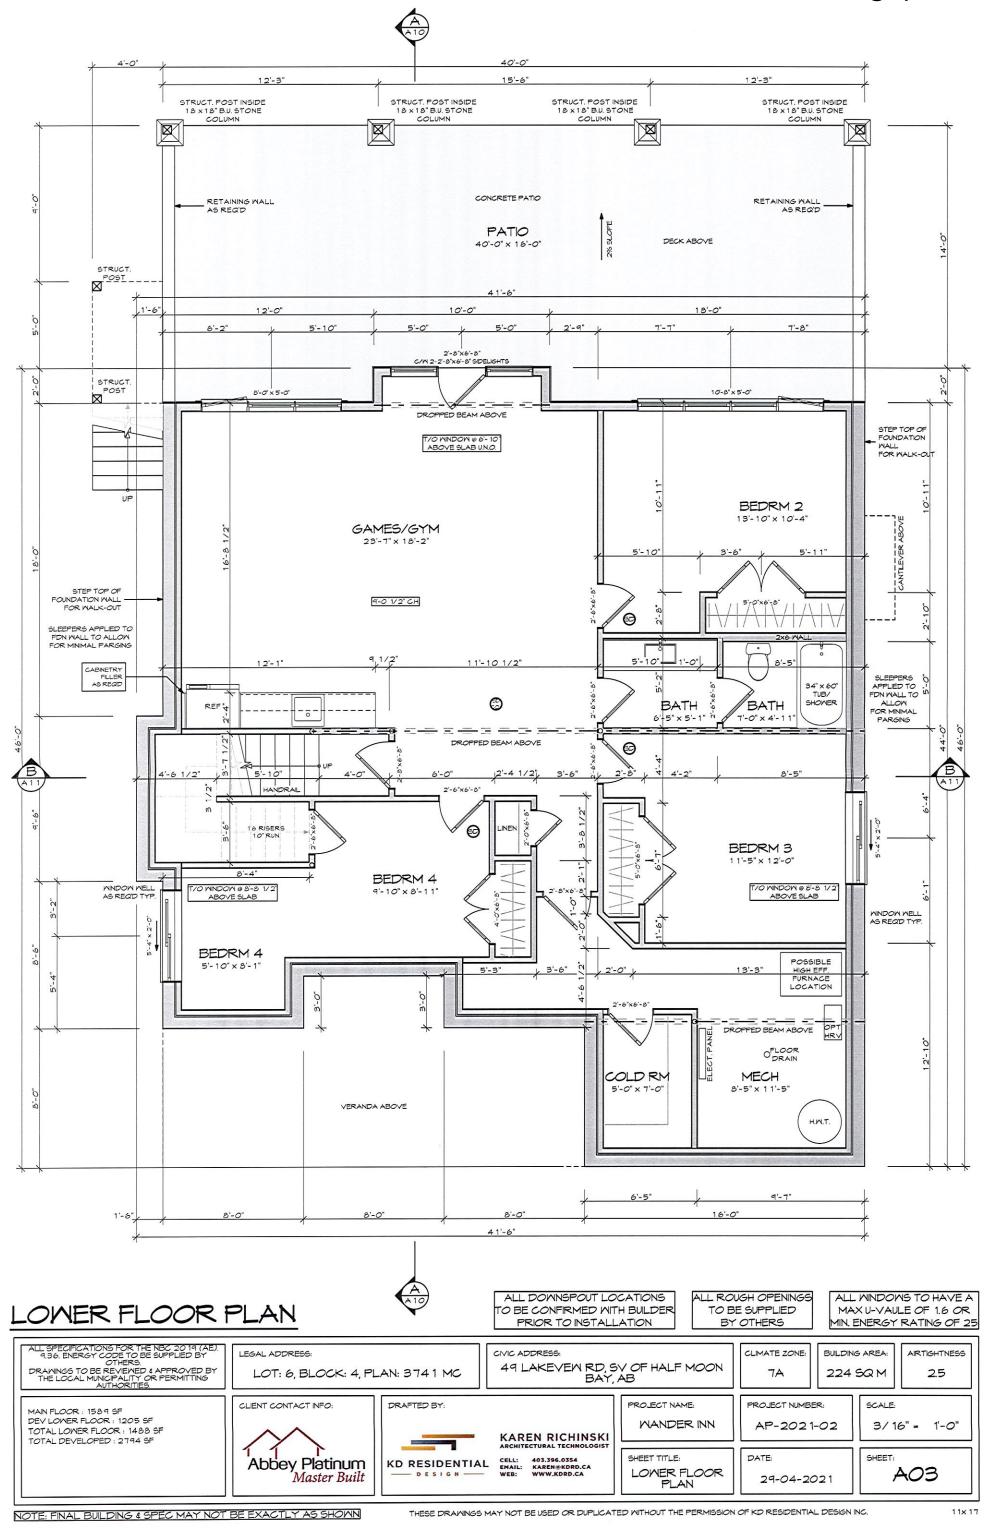

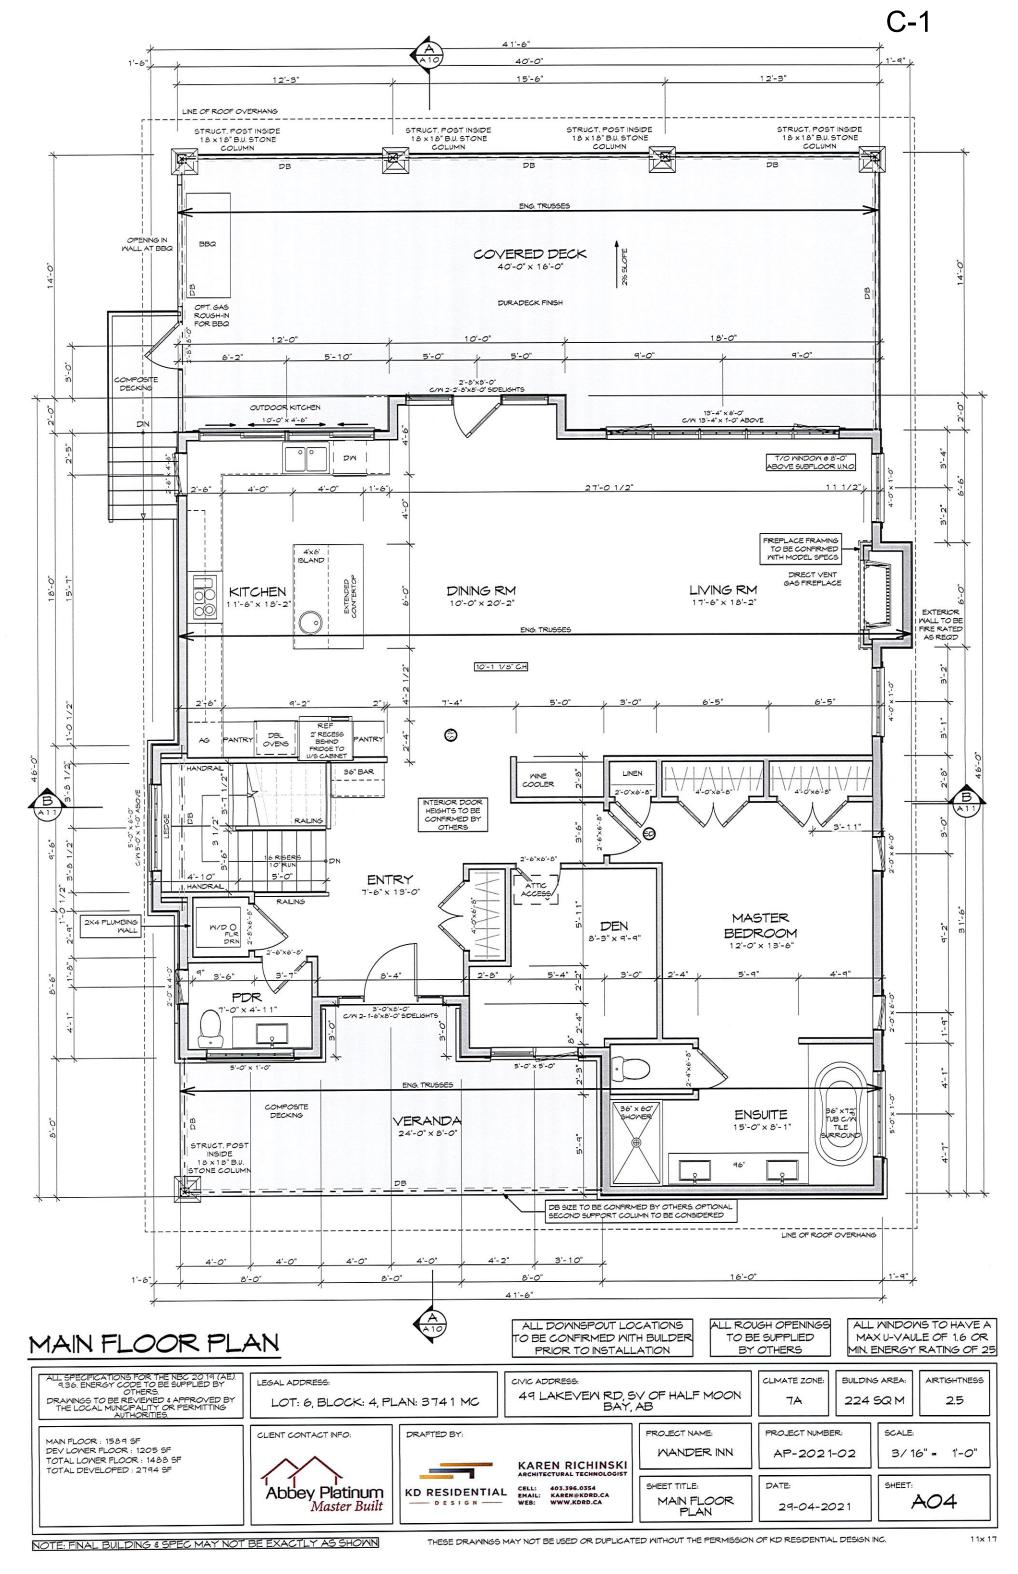

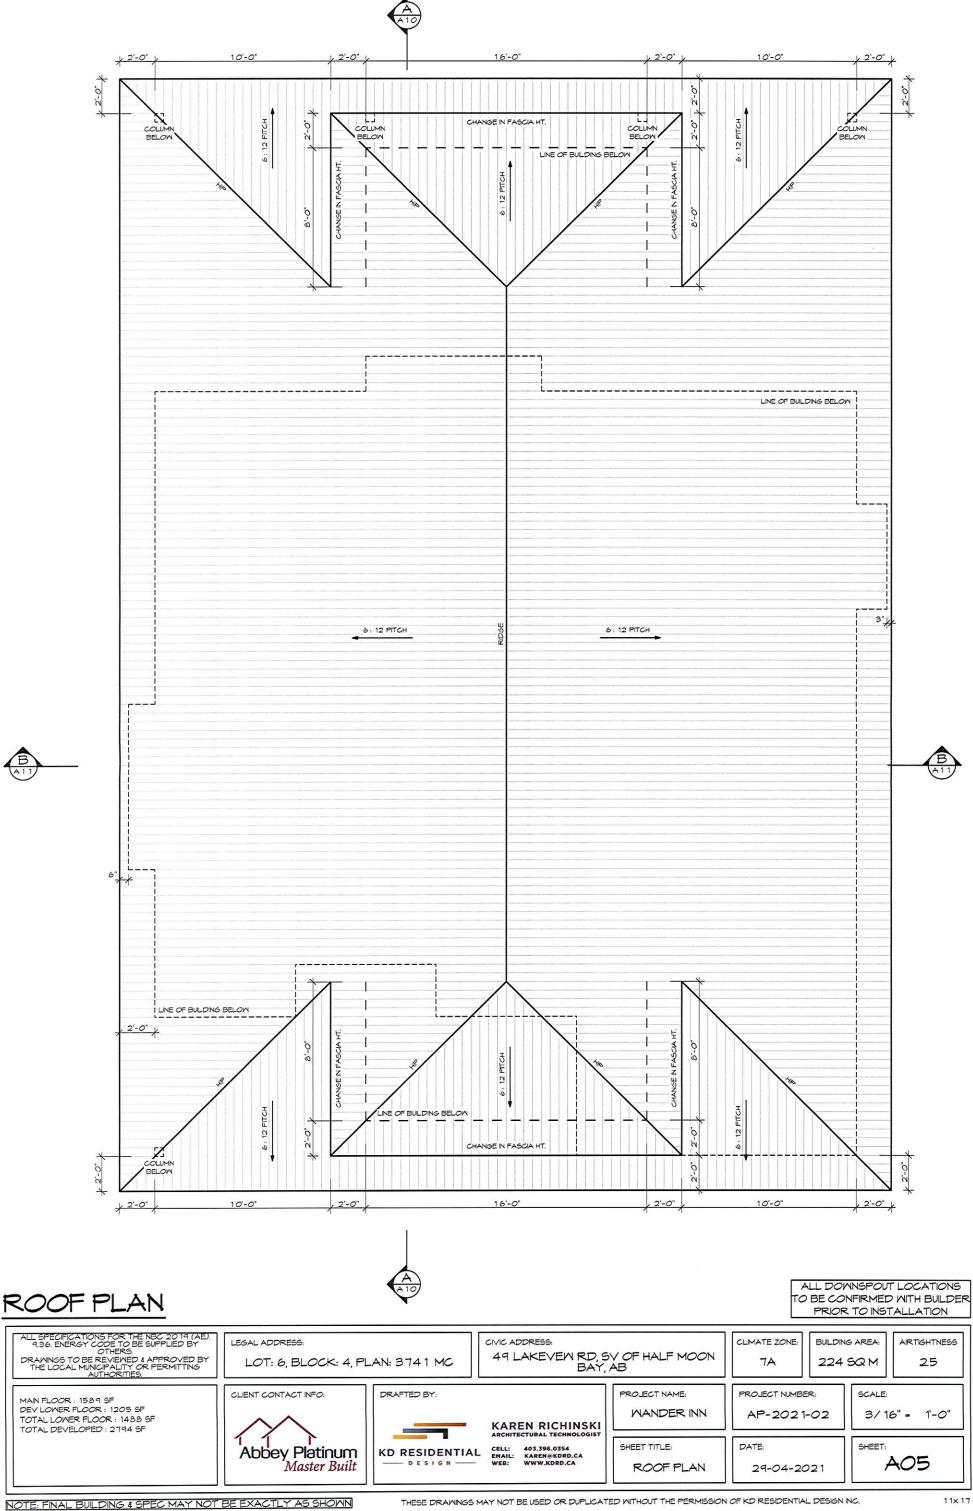

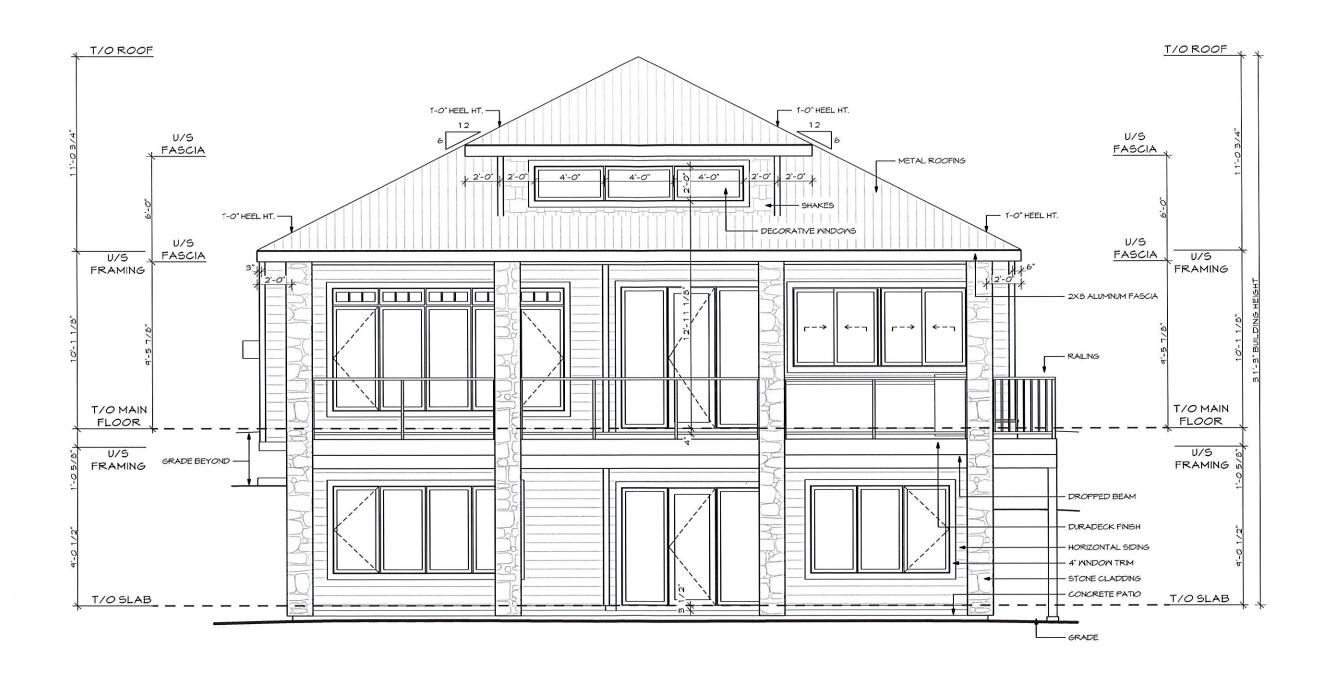

FRONT ELEVATION

ALL DOWNSPOUT LOCATIONS
TO BE CONFIRMED WITH BUILDER
PRIOR TO INSTALLATION

ALL GRADES TO BE CONFIRMED BY OTHERS PRIOR TO CONSTRUCTION

ALL SPECIFICATIONS FOR THE NBC 20 19 (AE), 9.36. ENERGY CODE TO BE SUPPLIED BY OTHERS.

DRAWINGS TO BE REVIEWED \$ APPROVED BY THE LOCAL MUNICIPALITY OR PERMITTING AUTHORITIES. MAN FLOOR: 1589 SF DEV LOWER FLOOR: 1205 SF TOTAL LOWER FLOOR: 1488 SF TOTAL DEVELOPED: 2794 SF CLIMATE ZONE:
7A
BUILDING AREA:
224 SQ M
ARTIGHTNESS
25

TA LOT: 6

LOT: 6, BLOCK: 4, PLAN: 3741 MC

CNIC ADDRESS:

49 LAKEVEW RD, SV OF HALF MOON
BAY, AB




CLIENT CONTACT INFO:

PROJECT NAME:

WANDER INN

PROJECT NUMBER: SCALE: 3/16" = 1'-0"

DATE: SHEET: A06

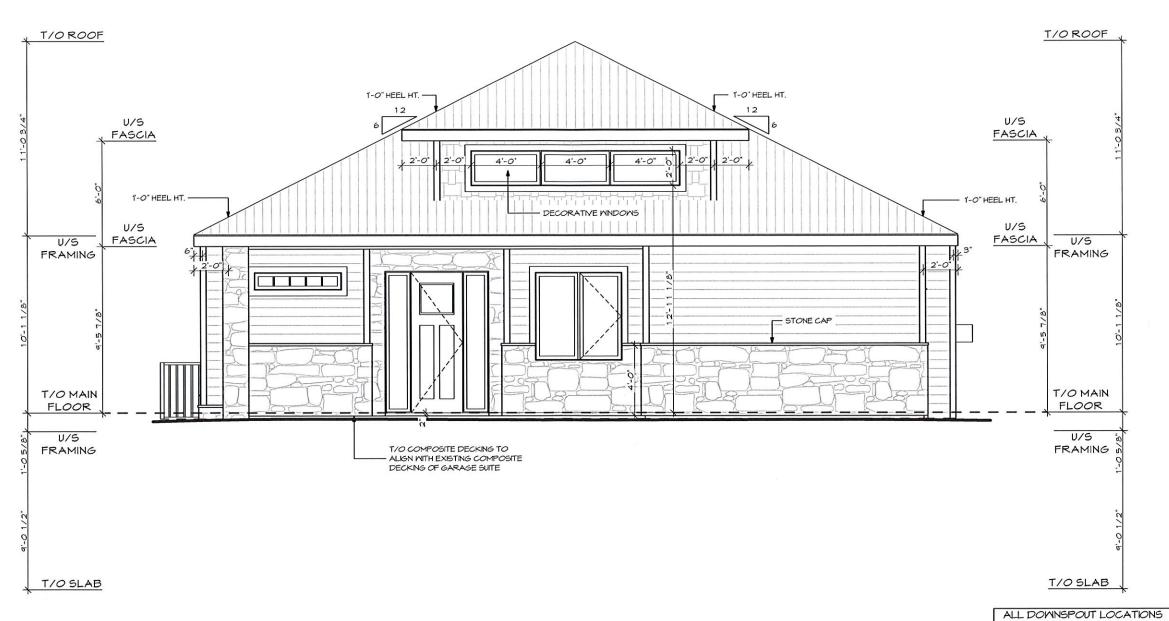

REAR ELEVATION

ALL SPECIFICATIONS FOR THE NBC 20 19 (AE), 9.36. ENERGY CODE TO BE SUPPLIED BY OTHERS. DRAWINGS TO BE REVIEWED \$ APPROVED BY THE LOCAL MUNICIPALITY OR PERMITTING AUTHORITIES.

MAIN FLOOR: 1589 SF DEV LOWER FLOOR: 1205 SF TOTAL LOWER FLOOR: 1488 SF TOTAL DEVELOPED: 2794 SF

CLIMATE ZONE: TA BULDING AREA 224 5Q M AIRTIGHTNESS 25

LEGAL ADDRESS: LOT: 6, BLOCK: 4, PLAN: 3741 MC 49 LAKEVEW RD, SV OF HALF MOON BAY, AB

Abbey Platinum Master Built

CLIENT CONTACT INFO:

KD RESIDENTIAL CELL: 403.396.0354
EMAIL: KAREN@KORD.CA
WEB: WWW.KDRD.CA

DRAFTED BY: KAREN RICHINSKI


PROJECT NAME: MANDER INN SHEET TITLE: **ELEVATIONS**

CONFIRMED BY OTHERS TO BE CONFIRMED WITH BUILDER PRIOR TO INSTALLATION PRIOR TO CONSTRUCTION PROJECT NUMBER: SCALE:

AP-2021-02 3/16" = 1'-0"

AOT 29-04-2021

ALL GRADES TO BE

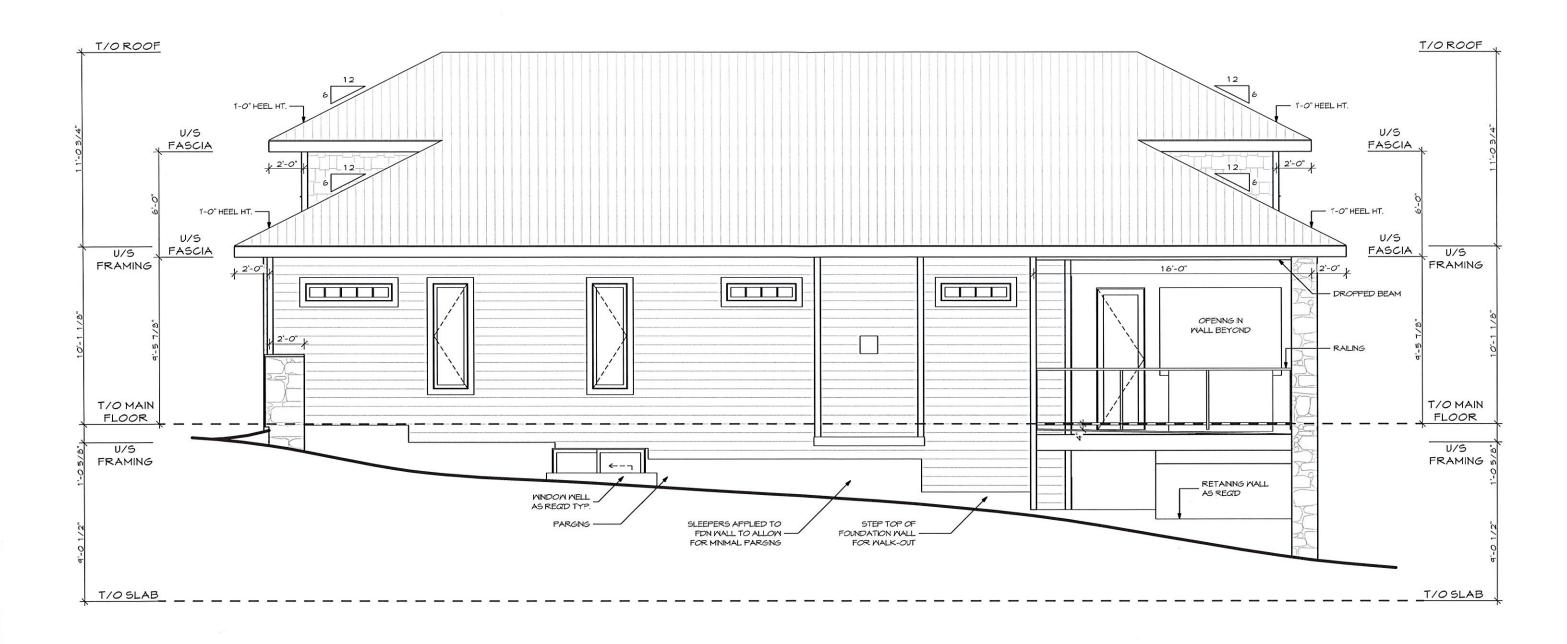

LEFT SIDE ELEVATION

THE FACE & SIDES OF WALLS AND UNDERSIDE OF CANTILEVERS WITHIN 1.2 M FROM PROPERTY LINE TO HAVE NON-COMBUSTIBLE CLADDING TO ACHIEVE 45 MIN. FIRE RESISTANCE RATING. -EITHER CEMENT BOARD CLADDING OR EXTERIOR DRYWALL BENEATH VINYL SIDING TO BE INSTALLED

UNVENTED SOFFIT REQUIRED ON EAVES CLOSER THAN 1.2 M TO PROPERTY LINE C/W ADDITIONAL ROOF VENTING AS RECOD ALL DOWNSPOUT LOCATIONS
TO BE CONFIRMED WITH BUILDER
PRIOR TO INSTALLATION

ALL GRADES TO BE CONFIRMED BY OTHERS PRIOR TO CONSTRUCTION

ALL SPECIFICATIONS FOR THE NBC 20 19 (AE), 9.36. ENERGY CODE TO BE SUPPLIED BY OTHERS.

DRAWINGS TO BE REVENED 4 APPROVED BY THE LOCAL MUNICIPALITY OR PERMITTING AUTHORITIES.

MAIN FLOOR: 1589 SF DEV LOMER FLOOR: 1205 SF TOTAL LOMER FLOOR: 1488 SF TOTAL DEVELOPED: 2794 SF CLIMATE ZONE:
7A
BULDING AREA:
224 SQ M
ARTIGHTNESS
25

LOT: 6, BLOCK: 4, PLAN: 3741 MC

CIVIC ADDRESS: 49 LAKEVEM RD, SV OF HALF MOON BAY, AB



KAREN RICHINSKI
ARCHITECTURAL TECHNOLOGIST

KD RESIDENTIAL
D E S I G N WEB: WWW.KDRD.CA


PROJECT NAME: PROJECT NAME: A

ELEVATIONS

PROJECT NUMBER: SCALE: 3/16" = 1'-0"

29-04-2021

SHEET:

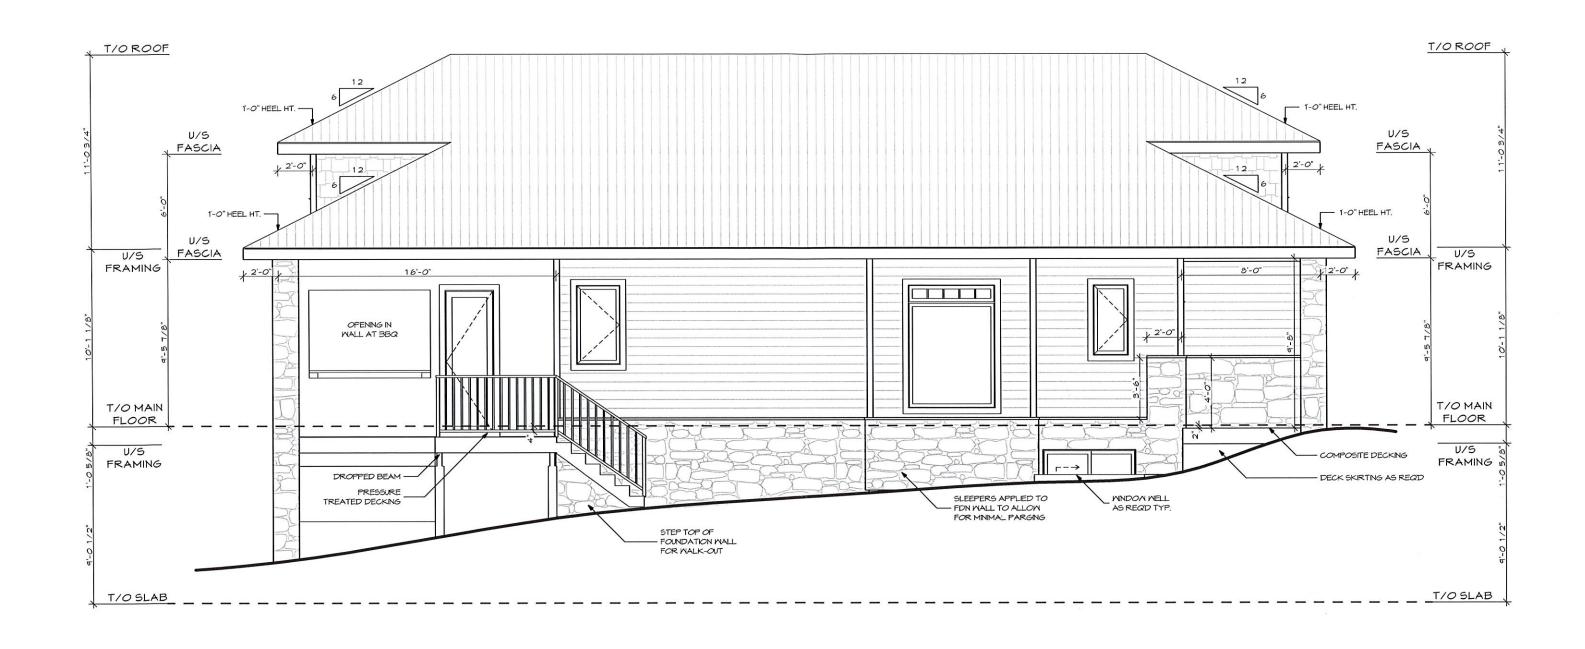

RIGHT SIDE ELEVATION

ALL SPECIFICATIONS FOR THE NBC 20 19 (AE), 9.36. ENERGY CODE TO BE SUPPLIED BY OTHERS.

MAN FLOOR: 1589 SF DEV LONER FLOOR: 1205 SF TOTAL LOWER FLOOR: 1488 SF TOTAL DEVELOPED: 2794 SF

CLIMATE ZONE: 7A BULDING ARE 224 5Q M AIRTIGHTNESS 25

LOT: 6, BLOCK: 4, PLAN: 3741 MC

49 LAKEVEW RD, SV OF HALF MOON

CLIENT CONTACT INFO: Abbey Platinum Master Built

DRAFTED BY: KAREN RICHINSKI KD RESIDENTIAL EMAIL:

DESIGN WEB:

ALL DOWNSPOUT LOCATIONS TO BE CONFIRMED WITH BUILDER PRIOR TO INSTALLATION PROJECT NUMBER


ALL GRADES TO BE CONFIRMED BY OTHERS PRIOR TO CONSTRUCTION

PROJECT NAME: MANDER INN

AP-2021-02

SCALE: 3/16" = 1'-0"

SHEET TITLE: DATE: SHEET: **ELEVATIONS** 29-04-2021

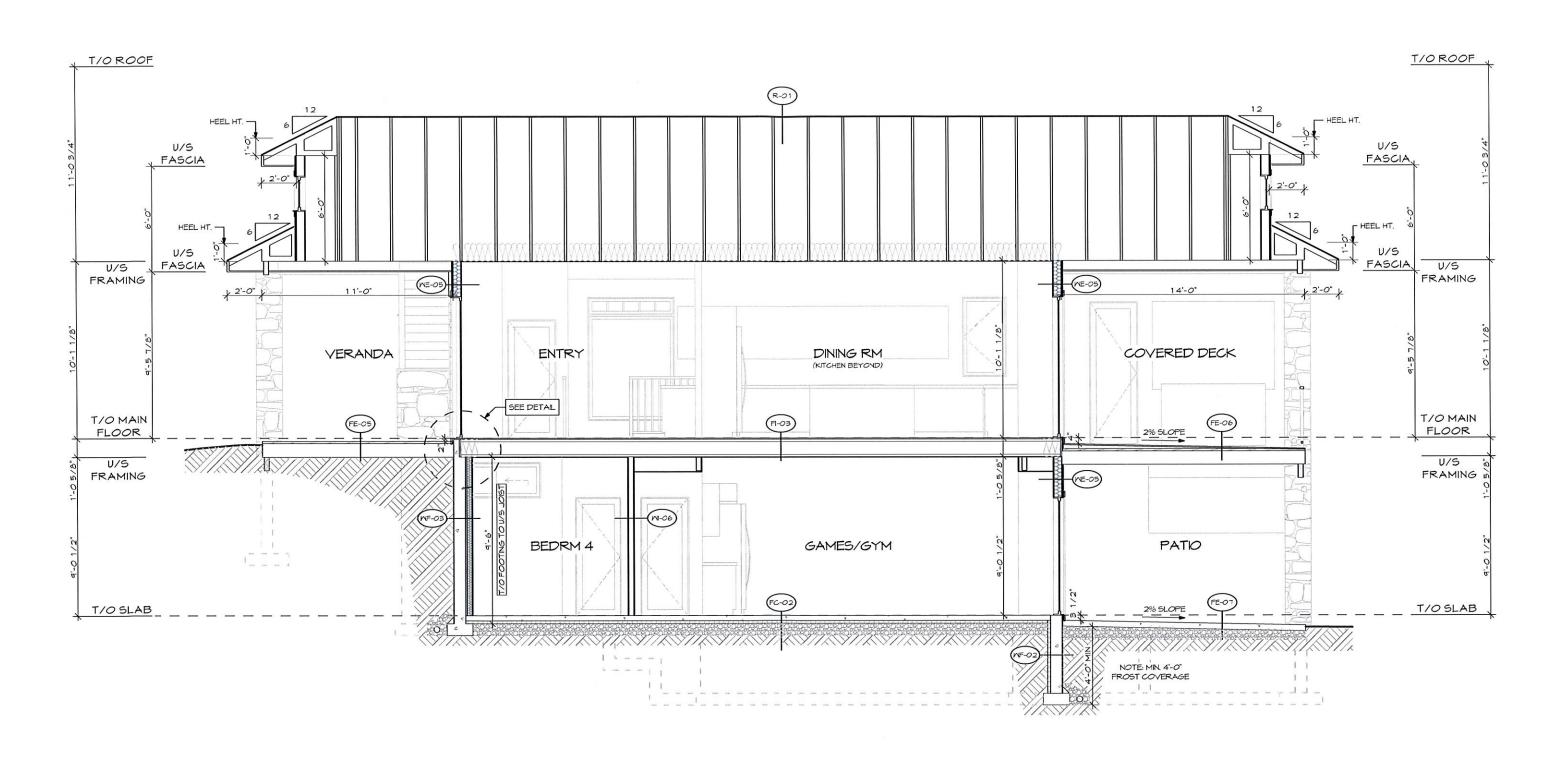

BUILDING SECTION A

DRAWINGS TO BE REVEMED & APPROVED BY THE LOCAL MUNICIPALITY OR PERMITTING AUTHORITIES.

MAN FLOOR: 1589 SF DEV LOMER FLOOR: 1205 SF TOTAL LOMER FLOOR: 1488 SF TOTAL DEVELOPED: 2794 SF

CLIMATE ZONE TA BUILDING AREA 224 5Q M AIRTIGHTNESS 25

LEGAL ADDRESS: LOT: 6, BLOCK: 4, PLAN: 3741 MC

49 LAKEVEW RD, SV OF HALF MOON BAY, AB

CLIENT CONTACT INFO: Abbey Platinum Master Built

DRAFTED BY: KAREN RICHINSKI KD RESIDENTIAL CELL: 403.396.0354

EMAIL: KAREN@KDRD.CA
WEB: WWW.KDRD.CA

PROJECT NAME: **MANDER INN**

PROJECT NUMBER: SCALE: AP-2021-02 3/16" = 1'-0"

DATE: BUILDING SECTIONS

CONSTRUCTION ASSEMBLIES

(AS FER NBC 2019 (AE))

T/O ROOF

U/5

FRAMING

T/0

MAIN

FLOOR

U/S FRAMING

T/O SLAB

HEEL HT.

NE-05

FASCIA,

FC-01 GARAGE SLAB ASSEMBLY (4")

4' CONCRETE SLAB - REINFORCED AS PER STRUCTURAL REQ.

FLOOR ASSEMBLIES

4 SLOPED AS SPECIFIED 6 MIL POLY VAPOUR BARRIER (9.25.4) 4' MIN. WASHED ROCK (9.16.2.1) UNDISTURBED SOIL

FC-02 BASEMENT ASSEMBLY (3 1/2")

3 1/2" CONCRETE SLAB - REINFORGED AS PER STRUCTURAL REQ.
6 MIL POLY VAPOUR BARRIER (9.25.4)
RIGID INSULATION (IF REQ'D) (9.36.2.8) 4" MIN. WASHED ROCK (9.16.2.1) UNDISTURBED SOIL

FI-03 RESIDENCE FLOOR ASSEMBLY (ABOVE GRADE)

FINISHED FLOOR AS SPECIFIED 3/4" T&G EXTERIOR GRADE SHEATHING (9.23.15) (OPT. BUILT-UP SHEATHING FOR FINISHED FLOOR SELECTIONS) TJI FLOOR SYSTEM - ENGINEERED BY OTHERS ACOUSTICAL INSULATION (WHERE APPLICABLE)
INSULATION @ JOIST ENDS & CANTILEVERED AREAS

(9.36.2.6)CROSS BRACING AS REQ'D 1/2° 6YPSUM BOARD (INTERIOR FINISHED SPACE) FINISH AS SPECIFIED (INTERIOR SPACE) SOFFIT (CANTILEVERED FLOOR AREAS)

FI-04 RESIDENCE FLOOR ASSEMBLY OVER GARAGE

FINISHED FLOOR AS SPECIFIED 3/4" T&G EXTERIOR GRADE SHEATHING (9.23.15) (OPT. BUILT-UP SHEATHING FOR FINISHED FLOOR SELECTIONS) TJI FLOOR SYSTEM - ENGINEERED BY OTHERS CROSS BRACING AS REQ'D 6 mil POLY VAPOUR BARRIER (9.25.4) STRAPPING AS REQ'D BELOW JOISTS FOR INSULATION INSULATION (9.36.2.6) 1/2" GYPSUM BOARD FIRE-TAPED AS REQ'D

FINISH AS SPECIFIED FE-05 EXTERIOR DECK ASSEMBLY

FOR FUME BARRIER

EXTERIOR GRADE WOOD DECKING WOOD JOISTS - AS PER STRUCTURAL REQ

FE-06 EXTERIOR DECK ASSEMBLY OPTION B

MATERPROOF MEMBRANE 3/4" T4G EXTERIOR GRADE SHEATHING MOOD JOISTS - AS PER STRUCTURAL REQ.(5LOPED)
CROSS BRACING AS REQ'D
VENTED SOFFIT

FE-07 PATIO SLAB ASSEMBLY

4" CONCRETE SLAB - REINFORCED AS PER STRUCTURAL DRAWINGS 6 MIL POLY VAPOUR BARRIER (9.25.4) 4" MIN. WASHED ROCK (9.16.2.1) UNDISTURBED SOIL

ROOF ASSEMBLIES

R-01 ROOF ASSEMBLY - SLOPED

FINISHED ROOFING AS SPECIFIED TRISPED NOTING AS PECHIED

EAVE PROTECTION (4.26.5)

7/16* OSB SHEATHING C/W H CLIPS (4.23.16)

PRE-ENGINEERED ROOF JOISTS / TRUSSES (ENGINEERED BY OTHERS)
INSULATION (ABOVE LIVING 5PACE)(9.36.2.6)
6 MIL POLY VAPOUR BARRIER
(ABOVE LIVING SPACE)(9.25.4) 1/2" GYPSUM BOARD VENTED SOFFIT @ EAVES (UNVENTED AS PER 3.2.3.6)

WALL ASSEMBLIES

MF-01 8" FROST WALL (GARAGE)

8" CONCRETE FOUNDATION WALL (9.15.4) DAMPPROOFING (BELOW FINISHED GRADE)(9.13.2) PARGING (ABOVE FINISHED GRADE)

MF-02 FROST MALL ASSEMBLY (WALK-OUT/CRAWL SPACE)

RIGID INSULATION (9.36.2.8) 8" CONCRETE FOUNDATION WALL (9.15.4) DAMPPROOFING (BELOW FINISHED GRADE)(9.13.2)

WF-03 CONCRETE FOUNDATION WALL ASSEMBLY

 $1/2^\circ$ GYPSUM BOARD MALL FINISH UNLESS NOTED OTHERWISE 6 MIL POLY VAPOR BARRIER (9.25.4) INSULATION (9.36.2.8) 1° AIR SPACE 8° CONCRETE FOUNDATION WALL (9.15.4) DAMPPROOFING (BELOW FINISHED GRADE)(9.13.2) PARGING (ABOVE FINISHED GRADE)

MF-04 CONCRETE FOUNDATION WALL ASSEMBLY W / FINSH

1/2" GYPSUM BOARD WALL FINISH UNLESS NOTED OTHERWISE 172 GTPSUM DOARD MALL FINISH UNLESS NOTED ON 6 MIL POLY VAPOR BARRIER (4.25.4) INSULATION (4.36.2.8) 2x4 K.D. SPRUCE/PINE STUDS (SPACING BY OTHERS) 1" AIR SPACE 6" CONCRETE FOUNDATION WALL (9.15.4) 3/8" OSB SHEATHING (9.23.17) PERMEABLE BUILDING PAPER (9.36.2.10)

ME-05 EXTERIOR WALL ASSEMBLY

FINISH AS SPECIFIED

1/2" GYPSUM BOARD WALL FINISH UNLESS NOTED OTHERWISE 172 OTF SIM BOARD MALE FINDS INCLESS NOTES OF 6 MILE POLY VAPOR BARRIER (4.25.4)
INSULATION (4.36.2.6)
2x6 K.D. SPRUCE/PINE STUDS (SPACING BY OTHERS) (P.T. MATERIAL BELON GRADE)

3/8" OSB SHEATHING (9.23.17)
PERMEABLE BUILDING PAPER (9.36.2.10)
FINISH AS SPECIFIED

MI-06 INTERIOR PARTITION MALL ASSEMBLY

1/2" GYPSUM BOARD WALL FINISH UNLESS NOTED OTHERMISE (MOISTURE RESISTANT GYPSUM IN BATHROOMS - WONDER BOARD IN SHOWERS) - NONZER DOARD IN SPONERS)
2X4 K.D. SPRUCE / PINE STUDS (SPACING BY OTHERS)
(UNLESS NOTED OTHERWISE)
ACOUSTICAL INSULATION (WHERE APPLICABLE) 1/2" GYPSUM BOARD WALL FINISH UNLESS NOTED OTHERWISE

MI-OT INTERIOR PARTITION WALL ASSEMBLY GARAGE/HOUSE (2x6) LOAD BEARING

1/2" GYPSUM BOARD WALL FINISH UNLESS NOTED OTHERWISE (MOISTURE RESISTANT GYPSUM IN BATHROOM:
- WONDER BOARD IN TILED SHOMERS)
6 MIL POLY VAPOUR BARRIER (9.25.4) INSULATION (93626) 2X6 K.D. SPRUCE / PINE STUDS (SPACING BY OTHERS)

1/2" GYPSUM BOARD WALL FINISH FIRE-TAPED AS REQ'D
FOR FUME BARRIER

BUILDING SECTION B

HEEL HT.

U/S

FASCIA

(NE-05)

(NF-03)

ALL SPECFICATIONS FOR THE NBC 20 19 (AE), 9.36, ENERGY CODE TO BE SUPPLIED BY OTHERS. DRAWINGS TO BE REVIEWED \$ APPROVED BY THE LOCAL MUNICIPALITY OR PERMITTING AUTHORITIES.

T/O ROOF

11/5

FRAMING

T/0

MAIN

FLOOR

U/S

FRAMING

T/O SLAB

MAIN FLOOR: 1589 5F DEV LOWER FLOOR: 1205 SF TOTAL LOWER FLOOR: 1488 SF TOTAL DEVELOPED: 2794 SF

NOTE: FINAL BUILDING & SPEC MAY NOT BE EXACTLY AS SHOWN

OUTLINE

OF STARS

BEHIND

CLIMATE ZONE TA BUILDING AREA 224 5Q M AIRTIGHTNESS

25

LEGAL ADDRESS:

DECORATIVE

MNDOMS BEYOND

ENTRY

(DINING RM BEYOND)

GAMES/GYM

(FC-02)

LOT: 6, BLOCK: 4, PLAN: 3741 MC

(NI-06

(NI-06)

MASTER

BEDRM

BEDRM 3

49 LAKEVEW RD, SV OF HALF MOON BAY AB

Abbey Platinum Master Built

CLIENT CONTACT INFO:

DRAFTED BY **KD RESIDENTIAL**

KAREN RICHINSKI CELL: EMAIL: 403.396.0354

MANDER INN SHEET TITLE:

BUILDING

SECTIONS

PROJECT NAME:

AP-2021-02 DATE:

29-04-2021

PROJECT NUMBER:


3/16" = 1'-0"

SCALE:

SHEET:


RAILING AS REQU

HANDRAL AS REQ'D

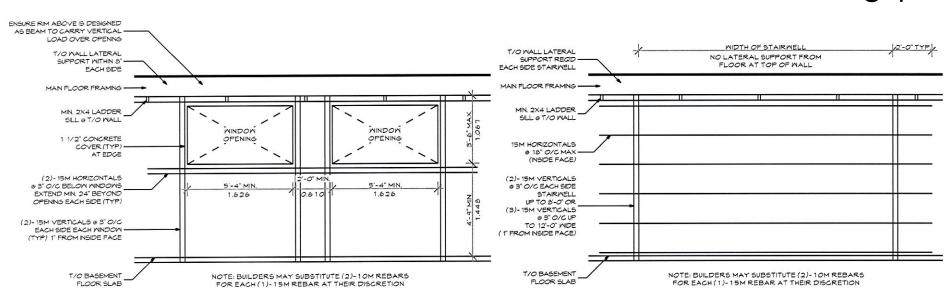

ADDITIONAL REINF. AT MINDOMS IN FDN

N.T.S. AHITC: GUIDELINES FOR LATERAL BRACING OF RESIDENTIAL CONCRETE FOUNDATION WALLS - SEPT 2009

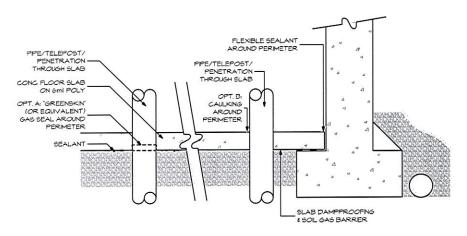

SLAB PENETRATION SEALING DTL

-KD RESIDENTIAL DESIGN INC. SHALL NOT BE HELD LIABLE AND ASSUMES NO RESPONSIBILITY FOR ANY HOME CONSTRUCTED FROM THESE DRAWINGS. IT IS THE CONTRACTORS RESPONSIBILITY TO VERIFY COMPLIANCE NITH LOCAL BUILDING CODES AND ANY MODIFICATIONS THAT MAY NEED TO BE MADE. THE CONTRACTOR IS ALSO RESPONSIBLE FOR VERIFYING SITE/SOIL CONTIONS AND ALL DIMENSIONS AND SQUARE FOOTAGE CALCULATIONS BEFORE BEGINNING CONSTRUCTION.

ALL STRUCTURAL INFORMATION IS TO BE USED AS A GUIDELINE ONLY. ALL STRUCTURE TO BE SIZED AND SUPPLIED BY OTHERS TO MEET ALL LOCAL BUILDING CODES.

ALL CONSTRUCTION TO CONFORM TO THE LATEST EDITION OF THE LOCAL BUILDING CODE, AS MELL AS ALL OTHER LOCAL CODES AND BY-LAMS.

GENERAL NOTES:

-CONTRACTOR TO REPORT ANY CHANGES, ERRORS OR OMISSIONS TO THEIR SUPERIOR BEFORE PROCEEDING.

-CONTRACTOR TO VERIFY AND BE RESPONSIBLE FOR ALL DIMENSIONS, SPECIFICATIONS AND CONSTRUCTION METHODS.

-CONTRACTOR TO CONFIRM THAT ANY DETAILS PROVIDED COMPLY WITH LOCAL BUILDING CODES AND METHODS OF CONSTRUCTION, AS DETAILS ARE ONLY TO BE USED AS A GUIDELINE.

FOUNDATION WATERPROOFING AND 4" PERFORATED TUBING TO BE PROVIDED WHERE EXTERIOR GRADE IS ABOVE THE BASEMENT SLAB OR CRAWL SPACE.

-EXTERIOR FLASHING TO BE APPLIED AT ALL CHANGES IN EXTERIOR MATERIALS, ABOVE ALL DOOR/ WINDOWS, AT ALL INTERSECTIONS BETWEEN WALLS AND ROOF, IN ALL ROOF VALLEYS AND AROUND ALL CHIMNEYS.

-ADDITIONAL FLASHING AND/OR CAULKING TO BE APPLIED AS PER LOCAL CODES TO ANY OTHER EXTERIOR SURFACES MITH POTENTIAL TO MEATHER.

-STEP FLASHING TO BE PROVIDED WHERE ANY ROOF SHINGLES ARE APPLIED AGAINST A VERTICAL SURFACE.

-ALL WINDOWS SHOWN ARE TO BE USED AS A GUIDELINE. CONTRACTOR TO VERIFY ALL ROUGH OPENINGS MITH SUPPLIER AND CONFIRM ANY CHANGES WITH THEIR SUPERIOR. CONTRACTOR IS ALSO RESPONSIBLE FOR SELECTING WINDOWS THAT MEET EGRESS AND TEMPERED GLASS REQUIREMENTS.

-ALL EXTERIOR DOORS/MINDOWS TO INCLUDE WEATHER-STRIPPING AS PER LOCAL BUILDING CODES.

-DOOR FROM HOUSE TO GARAGE TO BE INSTALLED WITH WEATER-STRIPPING AND A SELF-CLOSER DEVICE. -ROOF TO BE ADEQUATELY VENTED AS PER LOCAL BUILDING CODES AND REGULATIONS.

-CHIMNEYS SHALL EXTEND AT LEAST 2'-O" ABOVE ANY PORTION OF THE BUILDING WITHIN 10'-O" OR AS LOCAL BUILDING CODES.

-SERVICE LOCATIONS TO BE DETERMINED BY CONTRACTOR AND CONFIRMED BY THEIR SUPERIOR.

-ALL ANGLED WALLS ARE AT 45 DEGREES UNLESS NOTED OTHERWISE.

-CONTRACTOR TO BUILD-UP FLOORING AS REQUIRED TO ENSURE FINISHED FLOORING IS FLUSH AND LEVEL.

BLOCKING IS TO BE PROVIDED AT ALL CABINET AND HARDWARE LOCATIONS INCLUDING TOWEL BARS

-KITCHEN LAYOUT IS TO BE USED AS A GUIDELINE. SUPPLIER IS TO HAVE FINAL LAYOUT AND DETAILS APPROVED BY THEIR SUPERIOR.

-CAVITIES TO BE PROVDIED WHERE RECESS MEDICINE CABINETS ARE LOCATED.


-CONTRACTOR TO ENSURE FRAMING SUITS ELECTRICAL, PLUMBING AND MECHANICAL FIXTURES (INCLUDING FIREPLACES) AS SPECIFIED BY OTHERS.

-CONTRACTOR TO ENSURE THERE IS ADEQUATE ROOM FOR MECHANICAL CHASES, PLUMBING STACKS, ETC. -MECHANICAL EQUIPMENT LOCATIONS IS TO BE USED AS A GUIDELINE. CONTRACTOR TO CONFIRM FINAL LOCATION

-ALL ELECTRICAL WIRING AND PLACEMENT OF OUTLETS AND SMITCHES TO MEET LOCAL BUILDING CODES AND PROVIDE ADEQUATE SERVICE TO ALL APPLIANCES AND EQUIPMENT. ELECTRICAL LAYOUT TO BE USED AS A GUIDELINE WITH FINAL PLACEMENT AND FIXTURE SELECTION APPROVED BY THEIR SUPERIOR.

ADDITIONAL REINF. AT STAIRMELL FDN MALLS

AHITG: GUIDELINES FOR LATERAL BRACING OF RESIDENTIAL CONCRETE FOUNDATION WALLS - SEPT 2009

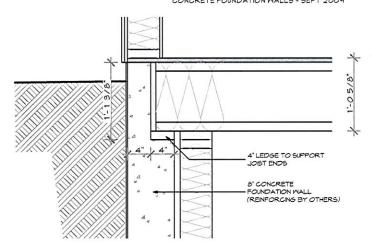

FDN WALL TO FLOOR DETAIL
SCALE 3/4" = 1'-0"

STRUCTURAL LEGEND DB DROPPED BEAM

FLUSH FRAMED BEAM

BP DJ DOUBLE JOIST GT GIRDER TRUSS LOAD BEARING WALL LBM

FB

LB LEDGER BOARD POINT LOAD ABOVE PAD FOOTING STRIP FOOTING SF ELECTRICAL LEGEND

