## MUNICIPAL PLANNING COMMISSION AGENDA SUMMER VILLAGE OF HALF MOON BAY SUMMER VILLAGES ADMINISTRATION OFFICE DECEMBER 19, 2023 @ 9:00 A.M.

- A. CALL TO ORDER
- B. ADOPTION OF AGENDA

#### C. DEVELOPMENT ITEMS

- 1. 10 Hummingbird Lane
- 2. 22 Hummingbird Lane

#### D. ADJOURNMENT

## Summer Village of Half Moon Bay – Municipal Planning Commission

### December 19, 2023

### Agenda Item

### 10 Hummingbird Lane (Lot 9, Block 2, Plan 3741MC)

### **Development Permit Application**

### **Background:**

In November 2023 a dwelling development permit was issued for the property at 10 Hummingbird Lane (Lot 2, Block 2, Plan 3741MC) in the village of Half Moon Bay. This property is located within the R District (Residential). This application before the Municipal Planning Commission today, has been applied for on behalf of the homeowner and is for a proposed detached garage with a guest house on the property.

The proposed garage with guest house is within the setback requirements, within the maximum height, and when the dwelling permit was approved the landscaping and drainage plans were approved as well. The proposed detached garage is to be 1,280.00ft<sup>2</sup> and to be separate and subordinate to the main dwelling. The garage is intended to be used for short term stay by guests of the main residence. The parcel coverage for the property is to be within the maximum 45%.

### **Discussion:**

This application is before MPC for the following reasons:


- Land Use Bylaw, Part Four, Land Use District Uses: An accessory building where the total floor area is over 74m<sup>2</sup> (796.54ft<sup>2</sup>) is listed as a Discretionary Use. The proposed detached garage is 118.9m<sup>2</sup> (1,280.00ft<sup>2</sup>) therefore requires approval from the Municipal Planning Commission.
- Land Use Bylaw, Part Four, Land Use District Uses: Guest Houses are listed as a discretionary use, therefore requires approval from the Municipal Planning Commission.

### **Application Review:**

After reviewing the application and all relevant planning documents, administration does not see any reason for the board to deny the discretionary use as requested. The proposed detached garage with guest house does not require any variances and meets the requirements of the Land Use Bylaw as mentioned above.

### **Conditions:**

If approved, Administration would recommend the following conditions:

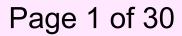

- Landscaping to be completed according to the landscaping plan. A minimum 35% of the parcel shall be a landscaped area.
- All applicable Building, Electrical, and Plumbing & Gas permits shall be obtained with Superior Safety Codes.
- The height of the garage with guest house shall not exceed 7.62m (25ft.) in building height measured from grade.
- An accessory building erected or placed on a parcel shall not be used as a dwelling unit.
- Completions deposit of \$5,000.00.
- The exterior of an accessory building must be finished to match or compliment the exterior finish of the main building.
- "Guest House" means an accessory building containing sleeping facilities for temporary usage only and may have a bathroom but shall not have a kitchen or other cooking facilities.
- In situations where a detached dwelling is being rented out and there is a guest house on the parcel, the guest house shall not to be rented out to a separate party other than those renting the detached dwelling.
- A lot grade certificate is required to be submitted to the Development Authority at completion to ensure proper drainage on the property exists.
- A final as build real property report from an Alberta Land Surveyor at completion of landscaping to ensure parcel coverage is within the maximum and to verify heights are within the maximum.

### Authorities:

For a discretionary use in any district:

(a) The Municipal Planning Commission may approve an application for a Development Permit:

(i) With or without conditions;


(ii) Based on the merits of the proposed development, including its relationship to any approved statutory plan, non-statutory plan or approved policy affecting the site;

(iii) Where the proposed development conforms in every respect to this Land Use Bylaw; or

(b) The Municipal Planning Commission may refuse an application


for a Development Permit based on the merits of the proposed development, even though it meets the requirements of this Land Use Bylaw; or (c) Subject to the provisions of section 2.4(2) the Municipal Planning Commission shall refuse an application for a Development Permit if the proposed development does not conform in every respect to this Land Use Bylaw.

**Decision:** 

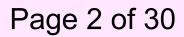

In order to retain transparency of the Commission, Administration recommends one of the following:

- 1. Approve the application with or without conditions (Section 642 of the MGA), or
- 2. Deny the application stating reasons why (Section 642(4) of the MGA).

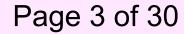



#38329 RANGE ROAD 20 RED DEER COUNTY, AB T4E 2L5

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## LETTER OF INTENT

NOVEMBER 17, 2023

HALF MOON BAY SV, AB DEVELOPMENT APPLICATION, ACCESSORY BUILDING 10 HUMMINGBIRD LN

TO WHOM IT MAY CONCERN:

AS PART OF OUR APPLICATION FOR ACCESSORY BUILDING (2 CAR GARAGE) WITH GUEST HOUSE ABOVE, WE WANT TO EXPRESS THE USE OF SUCH IS SOLEY FOR SHORT TERM STAY BY GUESTS OF THE MAIN RESIDENCE. THE SUITE DOES NOT INCLUDE COOKING FACILITIES. IT IS INTENDED TO MATCH THE DESIGN OF THE MAIN HOUSE AND FALL IN LINE WITH THE DISCRETIONARY USES AS OUTLINED IN THE HALFMOON BAY - LAND USE BYLAWS.

Signature DP Applicant RILEY HILMAN, KOTI HOMES LTD. Name DP Applicant

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# 10 HUMMINGBIRD LANE GARAGE SUITE



### LIST OF DRAWINGS

- A01 TITLE PAGE
- A02 FOUNDATION PLAN
- A03 MAIN FLOOR PLAN
- A04 UPPER FLOOR PLAN
- A05 ROOFPLAN
- A06 ELEVATIONS
- A07 ELEVATIONS
- A08 ELEVATIONS
- A09 BUILDING SECTIONS
- A 10 BUILDING SECTIONS

A11 BUILDING SECTIONS

A12 CNST DTLS / NOTES / LEGENDS

A13 SITE PLAN

EO1 MAIN FLOOR ELECTRICAL

EO2 UPPER FLOOR ELECTRICAL




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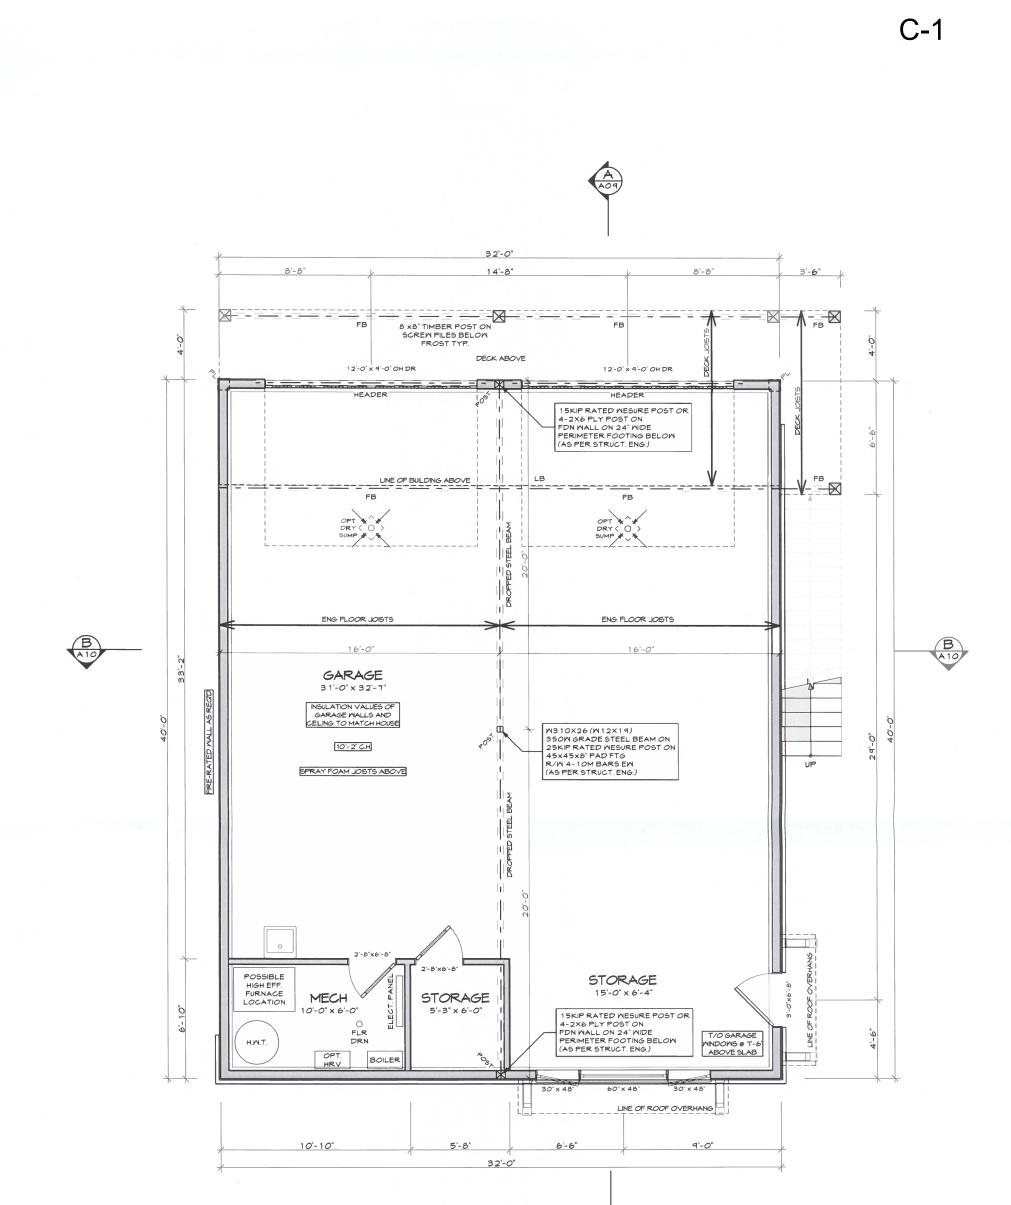


## FOUNDATION PLAN

ALL ICF WALLS SHOWN AS LOGIX 11 3/4" MIDE

ROUGH-IN FOR RADON EXTRACTION SYSTEM/ SUBFLOOR DEPRESSURIZATION SYSTEM TO BE INSTALLED AS PER BUILDING CODE REQUIREMENTS

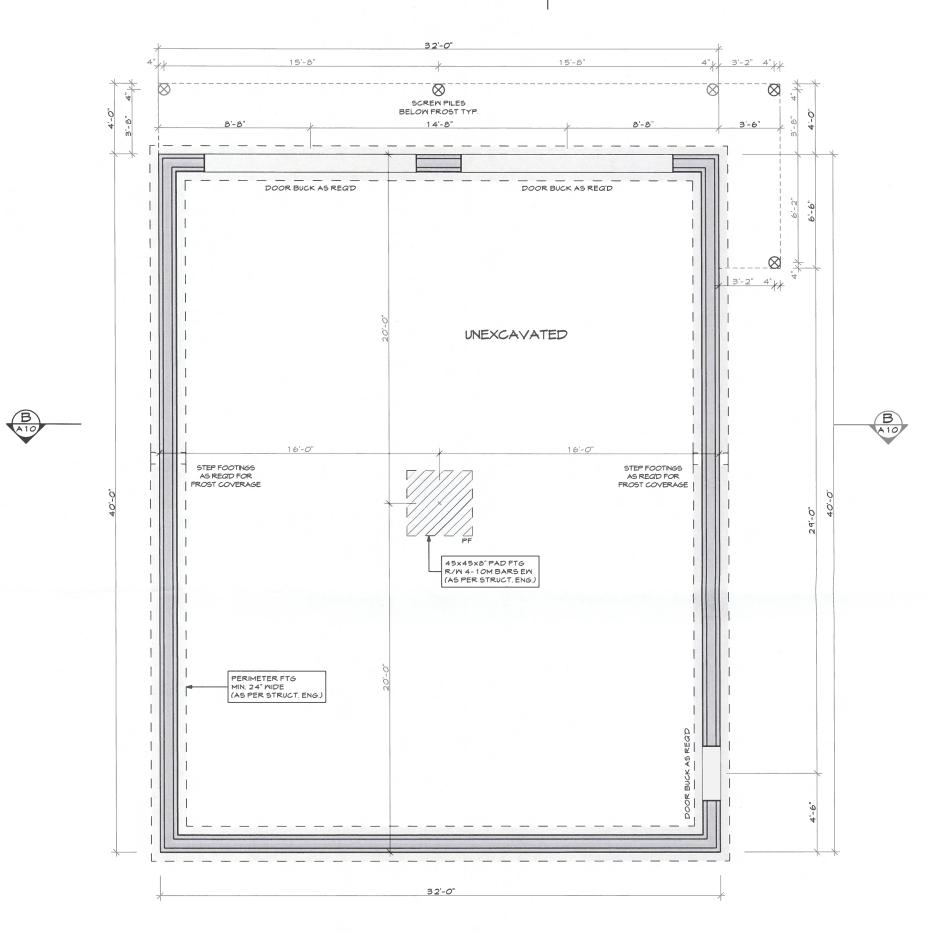



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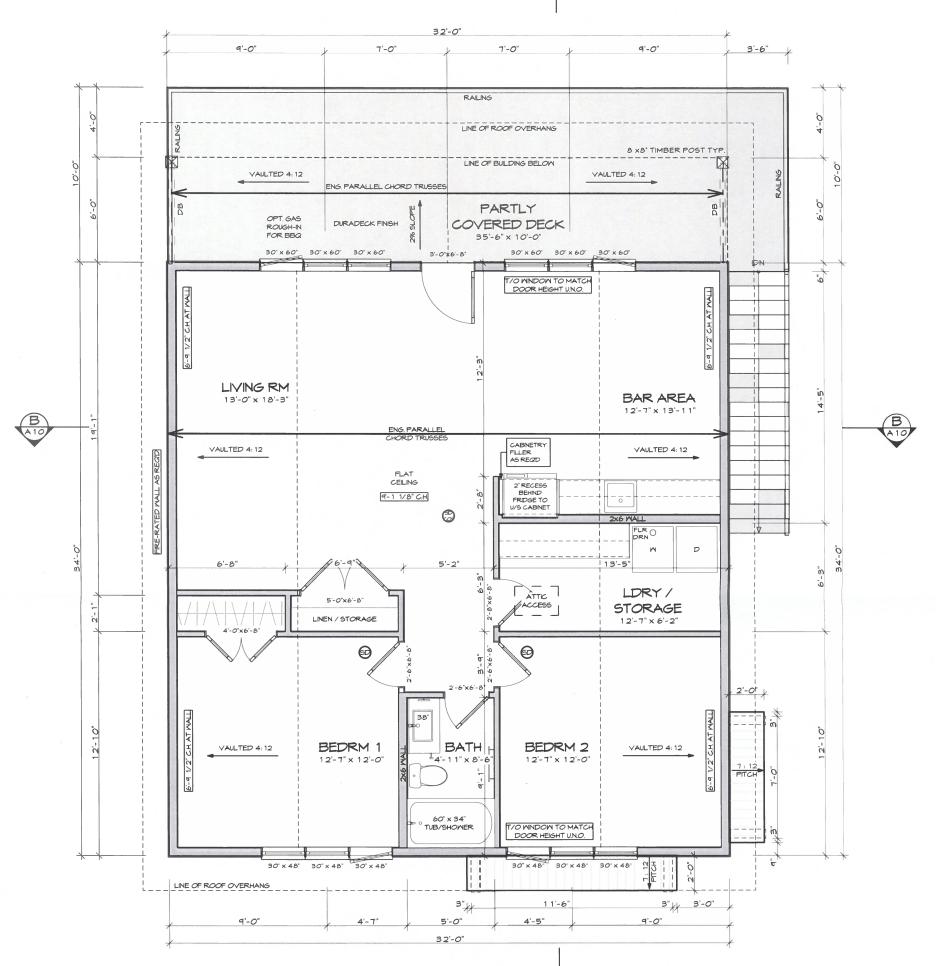
MAIN FLOOR PLAN

ALL DOWNSPOUT LOCATIONS TO BE CONFIRMED WITH BUILDER PRIOR TO INSTALLATION ALL ROUGH OPENINGS TO BE SUPPLIED BY OTHERS

ALL WINDOWS TO HAVE A MAX U-VAULE OF 1.6 OR MIN. ENERGY RATING OF 25







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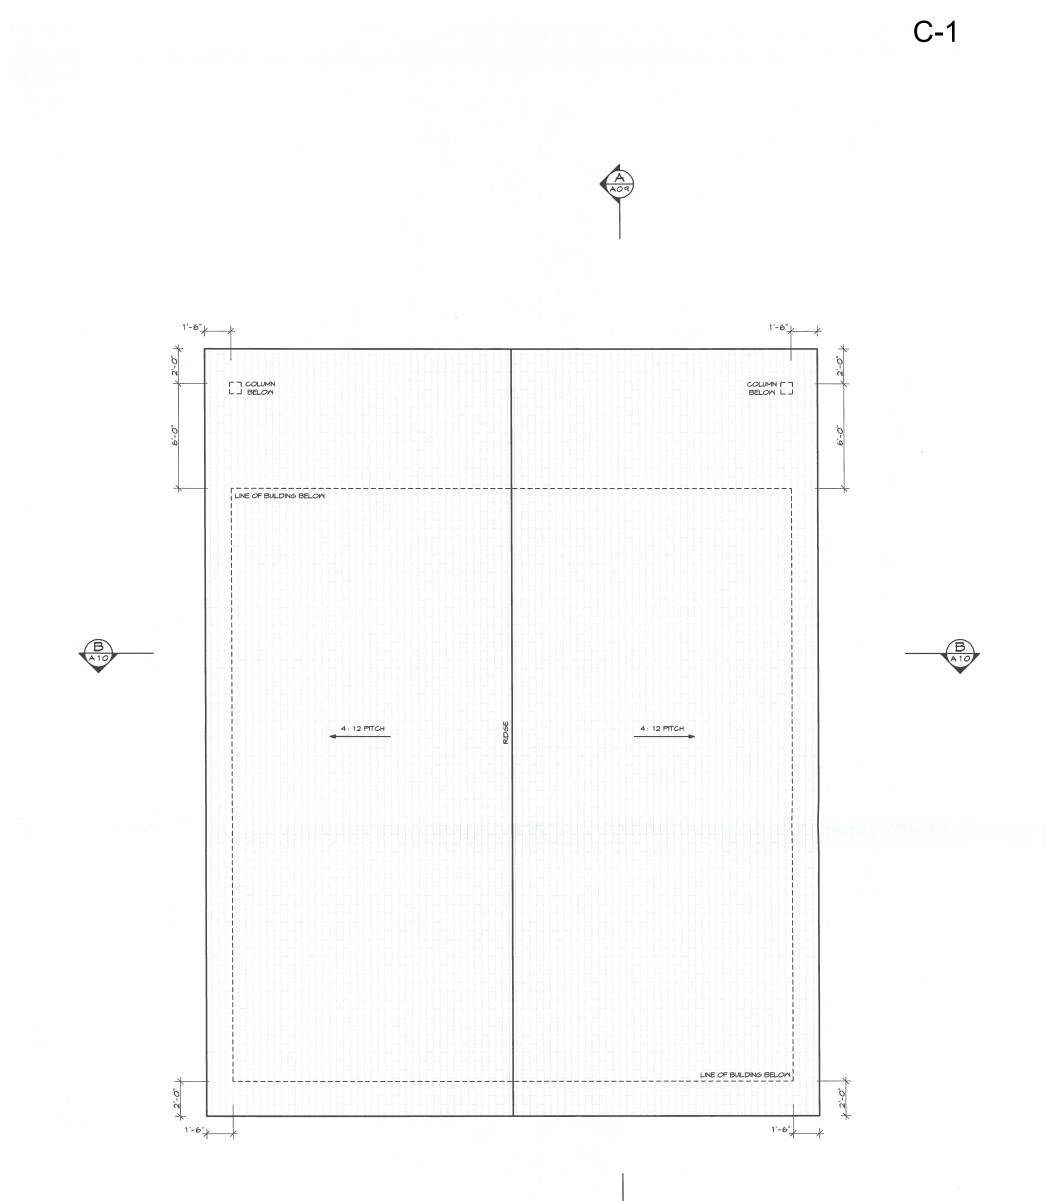
## UPPER FLOOR PLAN

ALL DOWNSPOUT LOCATIONS TO BE CONFIRMED WITH BUILDER PRIOR TO INSTALLATION

ALL ROUGH OPENINGS TO BE SUPPLIED BY OTHERS

ALL WINDOWS TO HAVE A MAX U-VAULE OF 1.6 OR MIN. ENERGY RATING OF 25





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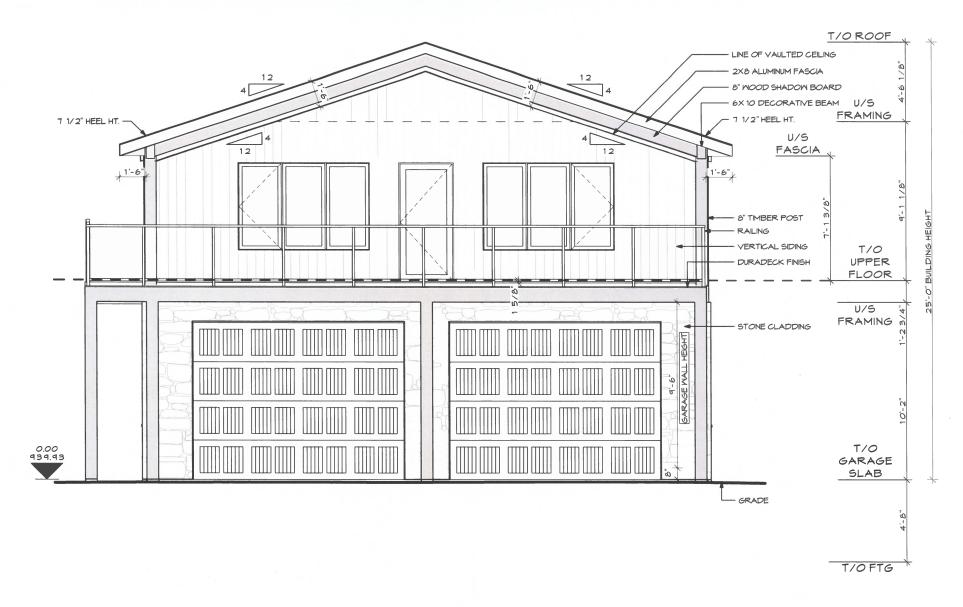
THESE DRAWINGS MAY NOT BE USED OR DUPLICATED WITHOUT THE PERMISSION OF KD RESIDENTIAL DESIGN INC.

ALL SPECIFICATIONS FOR THE NEC 2019 (AE). 9.36. ENERGY CODE TO BE SUPPLIED BY OTHERS. DRAWINGS TO BE REVIEWED & APPROVED BY THE LOCAL MUNCIPALITY OR PERMITTING AUTHORITIES.	LEGAL ADDRESS: LOT: 9, BLOCK: 2, PL	_AN: 3741 MC	CMIC ADDRESS: 10 HUMMINGBIRD LI MOON BI		CLIMATE ZONE: 7A	BUILDING AREA:	AIRTIGHTNESS
UPPER FLOOR : 1088 SF GARAGE : 1280 SF	CLIENT CONTACT INFO:	DRAFTED BY:	KAREN RICHINSKI	PROJECT NAME: 10 HUMMINGBIRD LANE GARAGE SUITE	PROJECT NUMBE		16" = 1'-0"
	KOTI HOMES	KD RESIDENTIAL		SHEET TITLE: ROOF PLAN	DATE: 2023-11	-28 SHEET:	A05


## ROOF PLAN

ALL DOWNSPOUT LOCATIONS TO BE CONFIRMED WITH BUILDER PRIOR TO INSTALLATION





FRONT ELEVATION

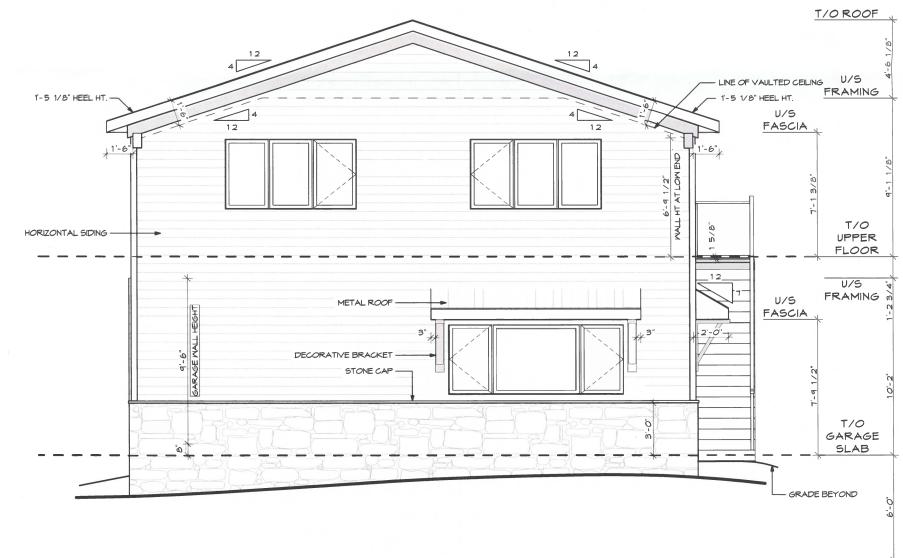

T/OFTG

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## REAR ELEVATION


ALL STRUCTURAL TIMBER	A
MATERIAL TO BE SIZED	TC
CONFIRMED BY OTHERS	

ALL DOWNSPOUT LOCATIONS TO BE CONFIRMED WITH BUILDER PRIOR TO INSTALLATION ALL GRADES TO BE CONFIRMED BY OTHERS PRIOR TO CONSTRUCTION

ALL SPECIFICATIONS FOR THE NEC 2019 (AE). 9.36. ENERGY CODE TO BE SUPPLIED BY OTHERS. DRAWINGS TO BE REVIEWED & APPROVED BY THE LOCAL MUNICIPALITY OR PERMITTING AUTHORITIES.	LEGAL ADDRESS: LOT: 9, BLOCK: 2, PL	_AN: 3741 MC	CMIC ADDRESS: 10 HUMMINGBIRD L, MOON B,		CLIMATE ZONE: 7A	BUILDING AREA:	AIRTIGHTNESS
UPPER FLOOR : 1088 SF GARAGE : 1280 SF		DRAFTED BY:	KAREN RICHINSKI	PROJECT NAME: 10 HUMMINGBIRD LANE GARAGE SUITE	PROJECT NUMBE		16" = 1'-0"
	DREAM DESIGN DOIED			SHEET TITLE: ELEVATIONS	DATE: 2023-11-	-28 SHEET:	A06

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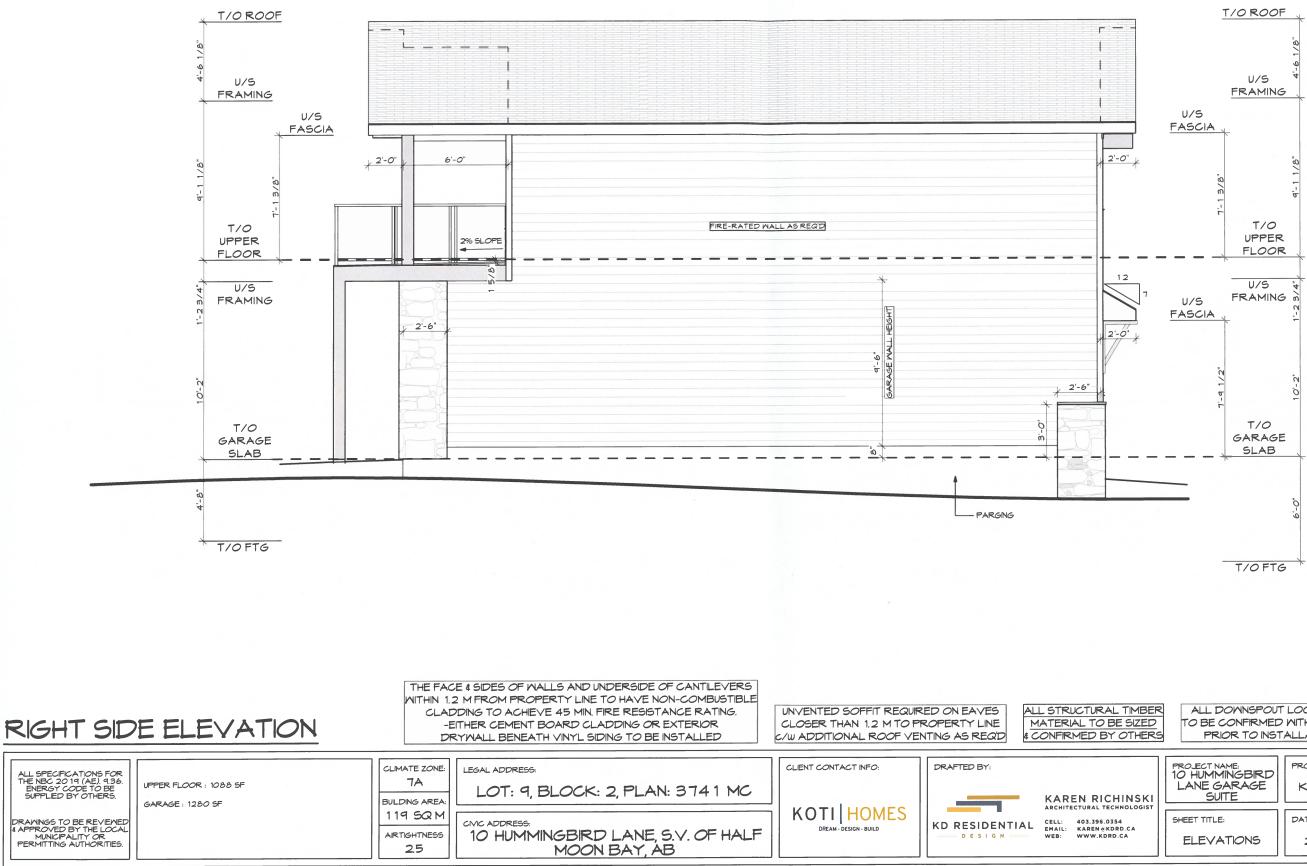
LEFT SID	EELEVATION				ALL STRUCTURAL TIMB MATERIAL TO BE SIZE & CONFIRMED BY OTHER
ALL SPECIFICATIONS FOR THE NBC 2019 (AE), 9.36. ENERGY CODE TO BE SUPPLIED BY OTHERS.	UPPER FLOOR : 1088 SF GARAGE : 1280 SF	CLIMATE ZONE: 7A BUILDING AREA:	LOT: 9, BLOCK: 2, PLAN: 3741 MC		DRAFTED BY:
DRAWINGS TO BE REVIEWED & APPROVED BY THE LOCAL MUNICIPALITY OR PERMITTING AUTHORITIES.		AIRTIGHTNESS 25	10 HUMMINGBIRD LANE, S.V. OF HALF MOON BAY, AB	KOTI HOMES	KD RESIDENTIAL CELL: 403.396.0354 EMAIL: KAREN & KDRD.CA DESIGN WEB: WWW.KDRD.CA

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IBER     ALL DOWNSPOUT LOCATIONS       ZED     TO BE CONFIRMED WITH BUILDER       HERS     PRIOR TO INSTALLATION			ALL GRADES TO BE DNFIRMED BY OTHERS DR TO CONSTRUCTION
SKI DOIST PROJECT NAME: 10 HUMMINGBIRD LANE GARAGE SUITE SHEET TITLE: ELEVATIONS		PROJECT NUMBER: KO-2023-03	SCALE: 3/16" = 1'-0"
		DATE: 2023-11-28	SHEET: AOT

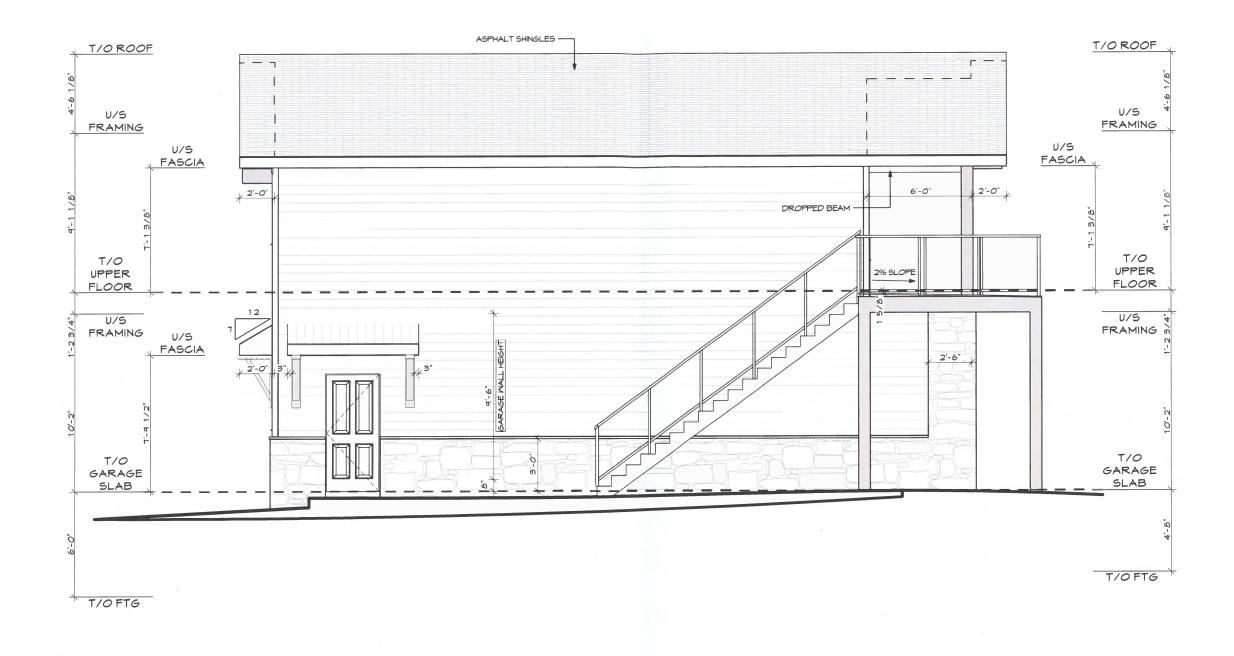


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ALL DOWNSPOUT ZED TO BE CONFIRMED HERS PRIOR TO INST,		WITH BUILDER C	ALL GRADES TO BE ONFIRMED BY OTHERS LOR TO CONSTRUCTION
PROJECT NAME: 10 HUMMINGBIRD LANE GARAGE SUITE		PROJECT NUMBER: KO-2023-03	SCALE: 3/16" = 1'-0"
GIST	SHEET TITLE: ELEVATIONS	DATE: 2023-11-28	AO8



## BUILDING SECTION A

CONSTRUCTION ASSEMBLIES (AS PER NBC 2019 (AE))

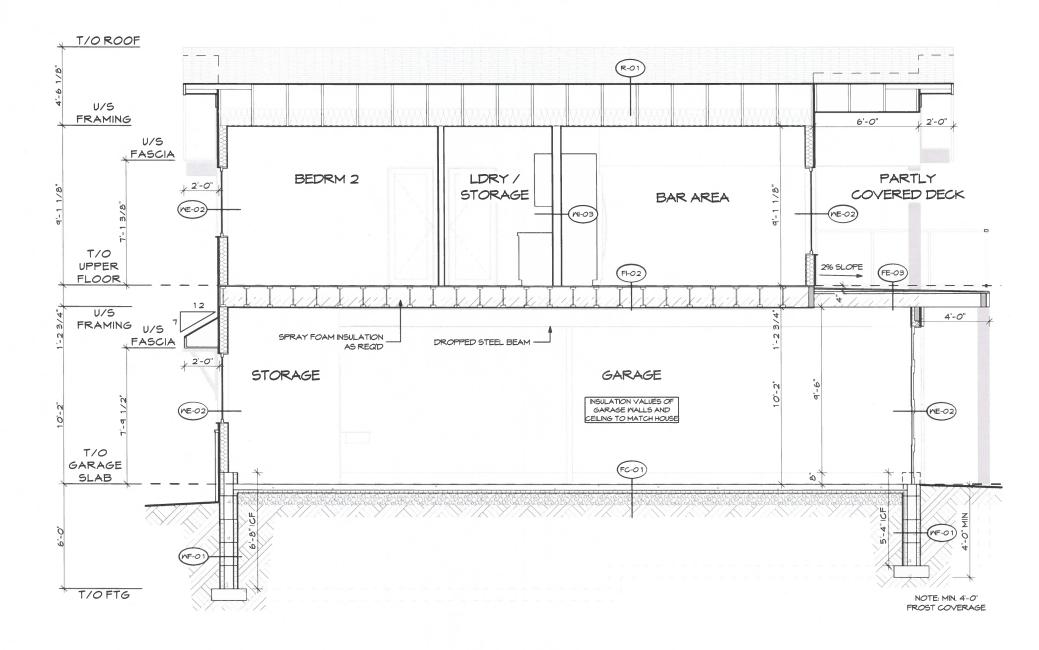WALL ASSEMBLIES

WF-01 ICF FROST WALL (GARAGE)

FLOOR ASSEMBLIES

FE-03 EXTERIOR DECK ASSEMBLY OPTION B

WATERPROOF MEMBRANE 3/4' T40 EXTERIOR GRADE SHEATHING (SLOPED) FRAMING AS REQD FOR SLOPE WOOD JOISTS - AS PER STRUCTURAL REQ.

ICF FOUNDATION WALL DAMPPROOFING (BELOW FINISHED GRADE)(9,13,2) PARGING (ABOVE FINISHED GRADE)

ME-02 EXTERIOR WALL ASSEMBLY

 1/2" GYP5UM BOARD MALL FINISH UNLESS NOTED OTHERMISE
 6 MIL POLY VAPOUR BARRIER (9.25.4)

 6 MIL POLY VAPOR BARRIER (9.25.4)
 4"MIN MASHED ROCK (9.16.2.1)

 1/3" (MIN MASHED ROCK (9.16.2.1)
 UNDISTURBED SOIL

 1/3" (MIN MASHED ROCK (9.16.2.1)
 UNDISTURBED SOIL

 1/3" (MIN MASHED ROCK (9.16.2.1)
 UNDISTURBED SOIL

 1/3" (MIN MASHED ROCK (9.16.2.1)
 FIO2 RESIDENCE FLOOR ASSEMBLY OVER GARAGE

 3/6" (MIN MASHED ROLK (9.26.2.10)
 FINISHED FLOOR AS SPECIFIED

 FINISH AS SPECIFIED
 3/4" TIG EXTERIOR GRADE SHEATHING (9.23.15)

 (OPT FUILT-UP SHEATHING FOR FINISHED FLOOR SEI
 GOPT FUILT-UP SHEATHING FOR FINISHED FLOOR SEI

WI-03 INTERIOR PARTITION WALL ASSEMBLY

1/2° GYPSUM BOARD WALL FINISH UNLESS NOTED OTHERWISE (MOISTURE RESISTANT GYPSUM IN BATHROOMS - WONDER BOARD IN SHOWERS) 2X4 K.D. SPRUCE / PINE STUDS (SPACING BY OTHERS) (UNLESS NOTED OTHERWISE) ACOUSTICAL INSULATION (WHERE APPLICABLE) 1/2" GYPSUM BOARD WALL FINISH UNLESS NOTED OTHERWISE

FC-01 GARAGE SLAB ASSEMBLY (4")

4" CONCRETE SLAB - REINFORCED AS PER STRUCTURAL REQ. 4 SLOPED AS SPECIFIED INSULATION (IF REQD) (4.36.2.8.) 6 MIL POLY VAPOUR BARRIER (4.25.4) 4" MIN, MASHED ROCK (4.16.2.1) INDISTIBETE SOU

FINISHED FLOOR AS SPECIFIED 3/4 TIG EXTERIOR GRADE SHEATHING (9,23,15) (OPT. BUILT-UP SHEATHING FOR FINISHED FLOOR SELECTIONS) TJI FLOOR SYSTEM - ENGINEERED BY OTHERS CROSS BRACING AS REQD 6 mil POLY VAPOUR BARRIER (9,25,4) 5 TRAPPING AS REQD BELOW JOISTS FOR INSULATION INSULATION (9,36,2,6) 1/2" GYPSUM BOARD FIRE-TAPED AS REQD FOR FUME BARRIER FINISH AS SPECIFIED

CROSS BRACING AS REQ'D VISULATION (IF REQD) (9.36.2.6) VENTED SOFFIT (EXTERIOR AREAS) FINISH AS SPECIFIED (INTERIOR SPACE) 1/2" GYPSUM BOARD FIRE-TAPED AS REQD FOR FUME BARRIER (GARAGE SPACE)

#### ROOF ASSEMBLIES

R-01 ROOF ASSEMBLY - SLOPED

FINISHED ROOFING AS SPECIFIED EAVE PROTECTION (9.26.5) 7/16" OSB SHEATHING C/W H CLIPS (9.23.16) PRE-ENGINEERED ROOF JOISTS / TRUSSES (ENGINEERED BY OTHERS) INSULATION (ABOVE LIVING SPACE)(9.36.2.6) 6 MIL POLY VAPOUR BARRIER (ABOVE LIVING SPACE)(9.25.4) 1/21 CYERUNA BOARS 1/2" GYPSUM BOARD VENTED SOFFIT @ EAVES (UNVENTED AS PER 3.2.3.6)


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C-1



BUILDING SECTION B

CONSTRUCTION ASSEMBLIES (AS PER NBC 2019 (AE))

WALL ASSEMBLIES

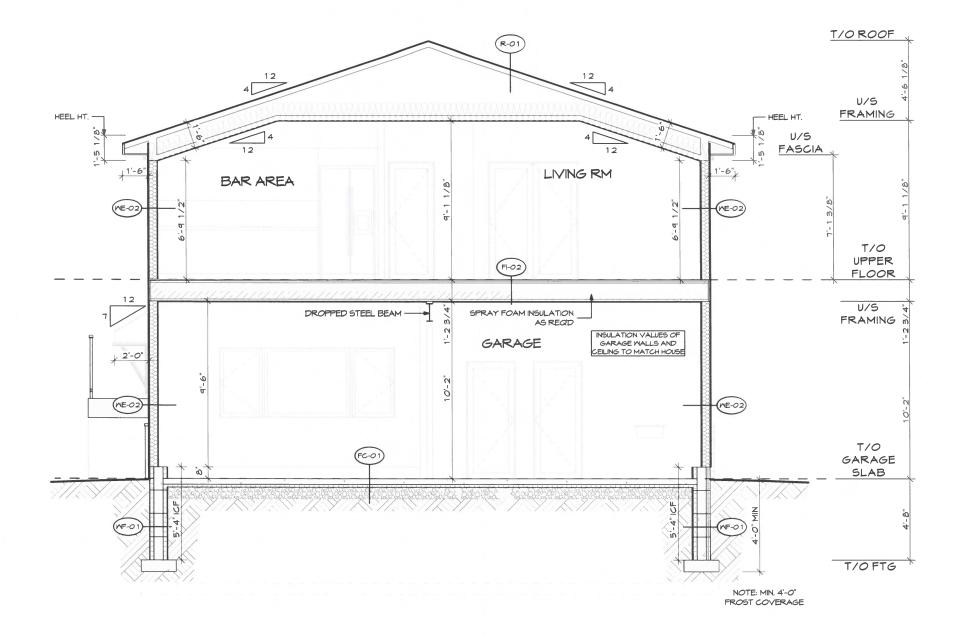FLOOR ASSEMBLIES

FE-03 EXTERIOR DECK ASSEMBLY OPTION B

WATERPROOF MEMBRANE 3/4' T46 EXTERIOR GRADE SHEATHING (SLOPED) FRAMING AS REQD FOR SLOPE WOOD JOISTS - AS PER STRUCTURAL REQ.

ICF FOUNDATION WALL DAMPPROOFING (BELOW FINISHED GRADE)(9.13.2) PARGING (ABOVE FINISHED GRADE)

WE-02 EXTERIOR WALL ASSEMBLY

 1/2" GYPSUM BOARD MALL FINISH UNLESS NOTED OTHERWISE
 16 ML POLY VAPOR BARRIER (9,25,4)

 6 ML POLY VAPOR BARRIER (9,25,4)
 0 MIN, MASHED ROCK (9,16,2,1)

 1/3" SUBATION (9,36,2,6)
 0 MIN, MASHED ROCK (9,16,2,1)

 2x6 K,D. SPRUCE/PINE STUDS (SPACING BY OTHERS) (P.T. MATERIAL BELOM GRADE)
 FI-02 RESIDENCE FLOOR ASSEMBLY OVER GARAGE

 3/6" OSB SHEATHING (9,23,17)
 FINISHEAD FLOOR AS SPECIFIED

 FINISH AS SPECIFIED
 7/4" T46 EXTERIOR GRADE SHEATHING (9,23,15)

MI-03 INTERIOR PARTITION WALL ASSEMBLY

1/2" GYPSUM BOARD WALL FINISH UNLESS NOTED OTHERWISE (MOISTURE RESISTANT GYPSUM IN BATHROOMS - WONDER BOARD IN SHOWERS) 2x4 K.D. SPRUCE / FINE STUDS (SPACING BY OTHERS) (UNLESS NOTED OTHERWISE) ACOUSTICAL INSULATION (MHERE APPLICABLE) 1/2" GYPSUM BOARD WALL FINISH UNLESS NOTED OTHERWISE

FC-01 GARAGE SLAB ASSEMBLY (4')

4" CONCRETE SLAB - REINFORCED AS PER STRUCTURAL REQ. 4 SLOPED AS SPECIFIED INSULATION (IF REQT) (9.36.2.8.) 6 MIL POLY VAPOUR BARRIER (9.25.4) 4 MIN, MASHED ROCK (9.16.2.1)

FINISHED FLOOR AS SPECIFIED 3/4" "4G EXTERIOR GRADE SHEATHING (9.23, 15) (OPT. BUILT-UP SHEATHING FOR FINISHED FLOOR SELECTIONS) TJIFLOOR SYSTEM - ENGINEERED BY OTHERS CROSS BRACING AS REQD 6 mil POLY VAPOUR BARRIER (9.25,4) STRAPFING AS REQD BELOW JOISTS FOR INSULATION INSULATION (9.36,2.6) 1/2" GYPSUM BOARD FIRE-TAPED AS REQD FOR FUME BARRIER FINISH AS SPECIFIED

MOOD JOISTS - AS PER STRUCTURAL R CROSS BRACING AS REQ'D INSULATION (IF REQ'D) (9.36.2.6) VENTED SOFFIT (EXTERIOR AREAS) FINISH AS SPECIFIED (INTERIOR SPACE) 1/2" GYPSUM BOARD FIRE-TAPED AS REQ'D FOR FUME BARRIER (GARAGE SPACE)

#### ROOF ASSEMBLIES

R-01 ROOF ASSEMBLY - SLOPED

FINISHED ROOFING AS SPECIFIED EAVE PROTECTION (4.26.5) 7/16°05B SHEATHING C/UH CLIPS (4.23.16) PRE-ENGINEERED ROOF JOISTS / TRUSSES (ENGINEERED BY OTHERS) INSULATION (ABOVE LIVING SPACE)(4.36.2.6) 6 MIL POLY VAPOUR BARRIER (ABOVE LIVING SPACE)(4.25.4) 1/2° SYPSUM BOARD VENTED SOFFIT @ EAVES (UNVENTED AS PER 3.2.3.6)

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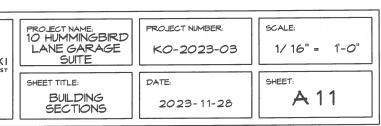
## WEST PROPERTY SECTION


ALL SPECIFICATIONS FOR THE NBC 20 19 (AE), 9,36. ENERGY CODE TO BE SUPPLIED BY OTHERS. DRAMINGS TO BE REVIEWED 4 APPROVED BY THE LOCAL MUNICIPALITY OR	UPPER FLOOR : 1088 SF GARAGE : 1280 SF	CLIMATE ZONE: 7A BUILDING AREA: 119 SQ M AIRTIGHTNESS	LEGAL ADDRESS: LOT: 9, BLOCK: 2, PLAN: 3741 MC CIVIC ADDRESS: 10 HUMMINGBIRD LANE, S.V. OF HALF	CLIENT CONTACT INFO: KOTI HOMES DREAM - DESIGN - BUILD	KD RESIDENTIAL	KAREN RICHINSK architectural technologis cell: 403.396.0354 email: karen ekord.ca web: www.kord.ca
PERMITTING AUTHORITIES.		25	MOON BAY, AB			

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## SLAB PENETRATION SEALING DTL

N.T.S.

#### GENERAL NOTES:

-KD RESIDENTIAL DESIGN INC. SHALL NOT BE HELD LIABLE AND ASSUMES NO RESPONSIBILITY FOR ANY HOME CONSTRUCTED FROM THESE DRAWINGS. IT IS THE CONTRACTORS RESPONSIBILITY TO VERIFY COMPLIANCE WITH LOCAL BUILDING CODES AND ANY MODIFICATIONS THAT MAY NEED TO BE MADE. THE CONTRACTOR IS ALSO RESPONSIBLE FOR VERIFYING SITE/SOIL CONDITIONS AND ALL DIMENSIONS AND SQUARE FOOTAGE CALCULATIONS BEFORE BEGINNING CONSTRUCTION.

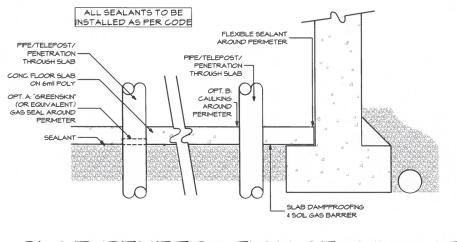-ALL STRUCTURAL INFORMATION IS TO BE USED AS A GUIDELINE ONLY. ALL STRUCTURE TO BE SIZED AND SUPPLIED BY OTHERS TO MEET ALL LOCAL BUILDING CODES.

-ALL CONSTRUCTION TO CONFORM TO THE LATEST EDITION OF THE LOCAL BUILDING CODE, AS WELL AS ALL OTHER LOCAL CODES AND BY-LAWS.

- DO NOT SCALE DRAWINGS.

-CONTRACTOR TO REPORT ANY CHANGES, ERRORS OR OMISSIONS TO THEIR SUPERIOR BEFORE PROCEEDING.

-CONTRACTOR TO VERIFY AND BE RESPONSIBLE FOR ALL DIMENSIONS, SPECIFICATIONS AND CONSTRUCTION METHODS.

-CONTRACTOR TO CONFIRM THAT ANY DETAILS PROVIDED COMPLY WITH LOCAL BUILDING CODES AND METHODS OF CONSTRUCTION, AS DETAILS ARE ONLY TO BE USED AS A GUIDELINE.

-FOUNDATION WATERPROOFING AND 4" PERFORATED TUBING TO BE PROVIDED WHERE EXTERIOR GRADE IS ABOVE THE BASEMENT SLAB OR CRAWL SPACE.

-EXTERIOR FLASHING TO BE APPLIED AT ALL CHANGES IN EXTERIOR MATERIALS, ABOVE ALL DOOR/ WINDOWS, AT ALL INTERSECTIONS BETWEEN WALLS AND ROOF, IN ALL ROOF VALLEYS AND AROUND ALL CHIMNEYS.

-ADDITIONAL FLASHING AND/OR CAULKING TO BE APPLIED AS PER LOCAL CODES TO ANY OTHER EXTERIOR SURFACES WITH POTENTIAL TO WEATHER.

-STEP FLASHING TO BE PROVIDED WHERE ANY ROOF SHINGLES ARE APPLIED AGAINST A VERTICAL SURFACE.

-ALL WINDOWS SHOWN ARE TO BE USED AS A GUIDELINE. CONTRACTOR TO VERIFY ALL ROUGH OPENINGS WITH SUPPLIER AND CONFIRM ANY CHANGES WITH THEIR SUPERIOR. CONTRACTOR IS ALSO RESPONSIBLE FOR SELECTING WINDOWS THAT MEET EGRESS AND TEMPERED GLASS REQUIREMENTS.

-ALL EXTERIOR DOORS/WINDOWS TO INCLUDE WEATHER-STRIPPING AS PER LOCAL BUILDING CODES.

-DOOR FROM HOUSE TO GARAGE TO BE INSTALLED WITH WEATER-STRIPPING AND A SELF-CLOSER DEVICE.

-ROOF TO BE ADEQUATELY VENTED AS PER LOCAL BUILDING CODES AND REGULATIONS.

-CHIMNEYS SHALL EXTEND AT LEAST 2'-0" ABOVE ANY PORTION OF THE BUILDING WITHIN 10'-0" OR AS LOCAL BUILDING CODES.

-SERVICE LOCATIONS TO BE DETERMINED BY CONTRACTOR AND CONFIRMED BY THEIR SUPERIOR.

-ALL ANGLED WALLS ARE AT 45 DEGREES UNLESS NOTED OTHERWISE.

-CONTRACTOR TO BUILD-UP FLOORING AS REQUIRED TO ENSURE FINISHED FLOORING IS FLUSH AND LEVEL.

-BLOCKING IS TO BE PROVIDED AT ALL CABINET AND HARDWARE LOCATIONS INCLUDING TOWEL BARS AND TOILET PAPER HOLDERS.

-KITCHEN LAYOUT IS TO BE USED AS A GUIDELINE. SUPPLIER IS TO HAVE FINAL LAYOUT AND DETAILS

STRUCTURAL LEGEN				
	DB	DROPPED BEAM		
	FB	FLUSH FRAMED BEAM		
3	BP	BEAM POCKET		
	DJ	DOUBLE JOIST		
	GT	GIRDER TRUSS		
	LBM	LOAD BEARING WALL		
	LB	LEDGER BOARD		
	PL	POINT LOAD ABOVE		
	PF	PAD FOOTING		
	SF	STRIP FOOTING		

## CELLING MOUNTED FIXTURE

Ø₽	RECESSED POT LIGHT	И	TELEPHONE
•	SMALL RECESSED POT LIGHT	C	CAT V WIRING
ф	MALL SCONCE	TV	CABLE OUTLET
$\Theta$	CEILING FAN	- <b>Đ</b> •	USB RECEPTACLE
×	UNDER CABINET LIGHT	$\bigcirc$	THERMOSTAT
<b>X</b> <sup>M</sup>	SHOWER POT	CV	CENTRAL VAC
Ø	EXHAUST FAN	÷ +	SMITCH
Φ	1 10V OUTLET	+	3 MAY SMITCH

ATTROVED DI THEIR SULLION.

-CAVITIES TO BE PROVDIED WHERE RECESS MEDICINE CABINETS ARE LOCATED.

-CONTRACTOR TO ENSURE FRAMING SUITS ELECTRICAL, PLUMBING AND MECHANICAL FIXTURES (INCLUDING FIREPLACES) AS SPECIFIED BY OTHERS.

-CONTRACTOR TO ENSURE THERE IS ADEQUATE ROOM FOR MECHANICAL CHASES, PLUMBING STACKS, ETC.

-MECHANICAL EQUIPMENT LOCATIONS IS TO BE USED AS A GUIDELINE. CONTRACTOR TO CONFIRM FINAL LOCATION WITH THEIR SUPERIOR.

-ALL ELECTRICAL WIRING AND PLACEMENT OF OUTLETS AND SWITCHES TO MEET LOCAL BUILDING CODES AND PROVIDE ADEQUATE SERVICE TO ALL APPLIANCES AND EQUIPMENT. ELECTRICAL LAYOUT TO BE USED AS A GUIDELINE WITH FINAL PLACEMENT AND FIXTURE SELECTION APPROVED BY THEIR SUPERIOR.




ALL SPECIFICATIONS FOR THE NBC 2019 (AE). 9.36. ENERGY CODE TO BE SUPPLED BY OTHERS. DRAWINGS TO BE REVIEWED & APPROVED BY THE LOCAL MUNCIPALITY OR PERMITTING AUTHORITIES.	LEGAL ADDRESS: LOT: 9, BLOCK: 2, PL	-AN: 3741 MC	CIVIC ADDRESS. 10 HUMMINGBIRD L MOON B		CLIMATE ZONE: 7A	BUILDING AREA: 119 SQ M	AIRTIGHTNESS 2.5
UPPER FLOOR : 1088 SF GARAGE : 1280 SF		DRAFTED BY:	KAREN RICHINSKI	PROJECT NAME: 10 HUMMINGBIRD LANE GARAGE SUITE	PROJECT NUMBE		
	ROTI HOMES	KD RESIDENTIA	CELL: 403.396.0354 Email: Karen@Kdrd.ca	SHEET TITLE: CNST DTLS / NOTES / LEGENDS	DATE: 2023-11-	-28 SHEET:	<u>4</u> 12

NOTE: FINAL BUILDING & SPEC MAY NOT BE EXACTLY AS SHOWN


THESE DRAWINGS MAY NOT BE USED OR DUPLICATED WITHOUT THE PERMISSION OF KD RESIDENTIAL DESIGN INC.

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EL	ECTRICAL LEGEN	>		
¤	CEILING MOUNTED FIXTURE	€	SPEAKER	
¤-	RECESSED POT LIGHT	И	TELEPHONE	
•	SMALL RECESSED POT LIGHT	2	CAT V WIRING	
14		F		

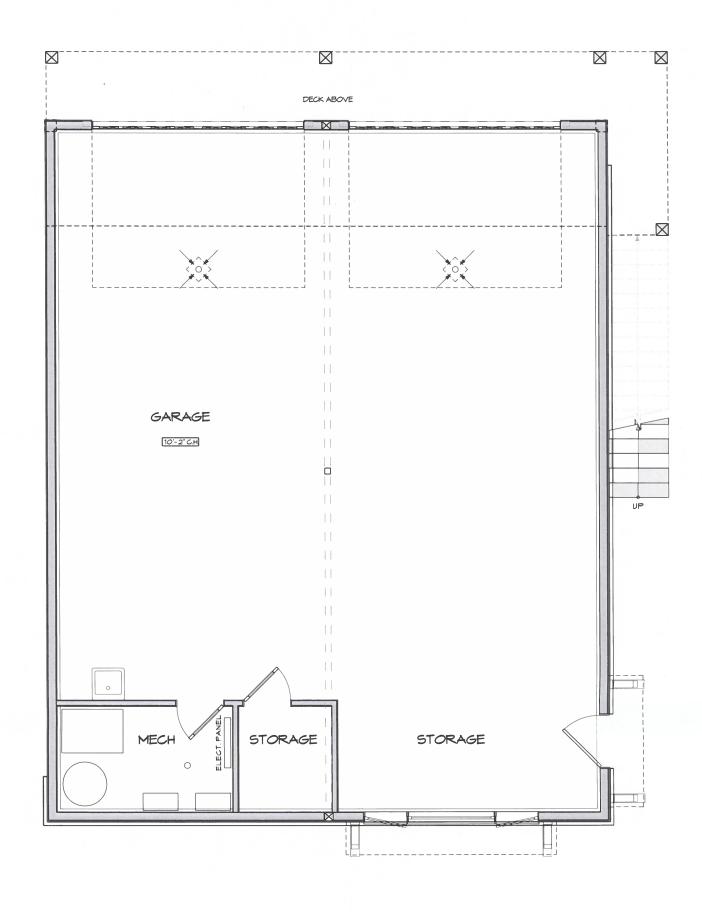


Page 17 of 30

## MAIN FLOOR ELECTRICAL

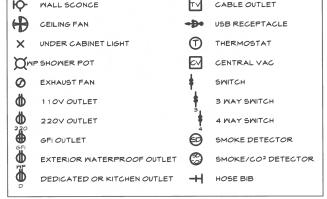


NOTE: FINAL BUILDING & SPEC MAY NOT BE EXACTLY AS SHOWN

THESE DRAWINGS MAY NOT BE USED OR DUPLICATED WITHOUT THE PERMISSION OF KD RESIDENTIAL DESIGN INC.

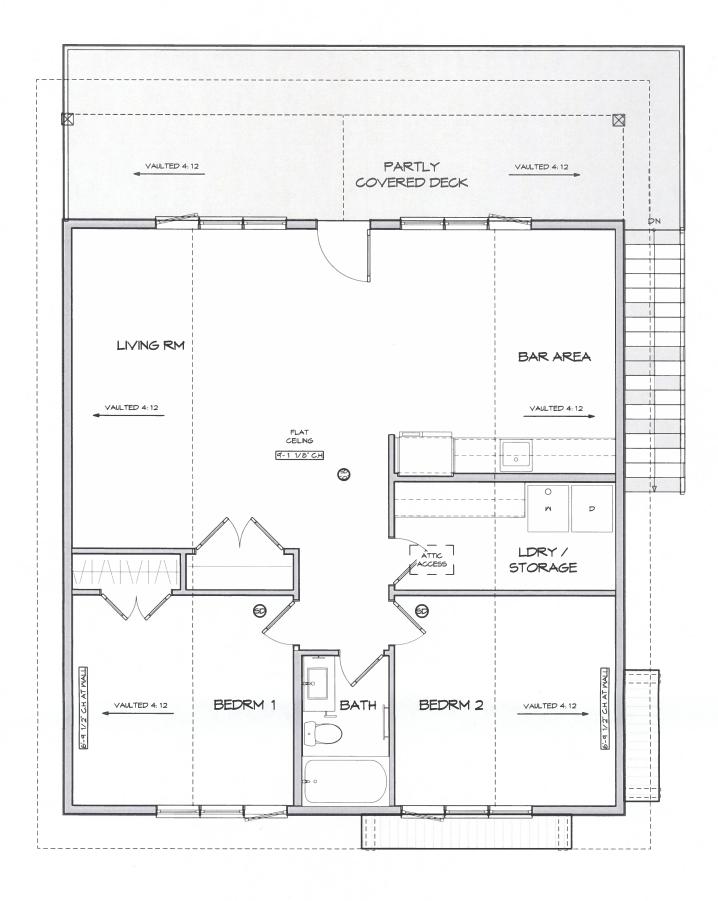

EL	ECTRICAL LEGEND		
¤	CEILING MOUNTED FIXTURE	ĸ	SPEAKER
¤₽	RECESSED POT LIGHT	И	TELEPHONE
•	SMALL RECESSED POT LIGHT	C	CAT V WIRING
4		<b>F</b> .	

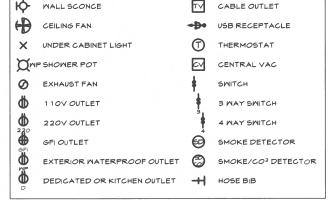

## UPPER FLOOR ELECTRICAL

ALL SPECIFICATIONS FOR THE NBC 2019 (AE). 9.36. ENERGY CODE TO BE SUPPLED BY OTHERS. DRAWINGS TO BE REVIEWED & APPROVED BY THE LOCAL MUNCIPALITY OR PERMITTING AUTHORITIES.	LEGAL ADDRESS: LOT: 9, BLOCK: 2, PLAN: 3741 MC		CMIC ADDRESS. 10 HUMMINGBIRD L. MOON B,		CLIMATE ZONE: 7A	BUILDING AREA: 119 SQ M		
UPPER FLOOR : 1088 SF GARAGE : 1280 SF		DRAFTED BY:	KAREN RICHINSKI ARCHITECTURAL TECHNOLOGIST CELL: 403.396.0354 - EMAIL: KAREN & KORD.CA WEB: WWW.KDRD.CA	PROJECT NAME: 10 HUMMINGBIRD LANE GARAGE SUITE	PROJECT NUMBE		scale: 3/16" = 1'-0"	
	KOTI HOMES	KD RESIDENTIAL		SHEET TITLE: UPPER FLOOR ELECTRICAL	DATE: 2023-11-	-28	E02	


NOTE: FINAL BUILDING & SPEC MAY NOT BE EXACTLY AS SHOWN

THESE DRAWINGS MAY NOT BE USED OR DUPLICATED WITHOUT THE PERMISSION OF KD RESIDENTIAL DESIGN INC.

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## SITE PLAN

ALL SPECIFICATIONS FOR THE NBC 2019 (AE). 9.36. ENERGY CODE TO BE SUPPLIED BY OTHERS. DRAWINGS TO BE REVIEWED & APPROVED BY THE LOCAL MUNCIPALITY OR PERMITTING AUTHORITIES.	LEGAL ADDRESS. LOT: 9, BLOCK: 2, PL	-AN: 3741 MC	CIVIC ADDRESS: 10 HUMMINGBIRD L. MOON B.	CLIMATE ZONE: 7A	BUILDING AREA: 119 SQ M	AIRTIGHTNESS 2.5		
UPPER FLOOR : 1088 SF GARAGE : 1280 SF	CLIENT CONTACT INFO: KOTI HOMES DREAM - DESIGN - BUILD	DRAFTED BY:	EMAIL: KARENGKORD, CA	PROJECT NAME: 10 HUMMINGBIRD LANE GARAGE SUITE	PROJECT NUMBE		SCALE. 1:200	
				SHEET TITLE: SITE PLAN	DATE: 2023-11-	-28 SHEET:	. 13	


NOTE: FINAL BUILDING & SPEC MAY NOT BE EXACTLY AS SHOWN

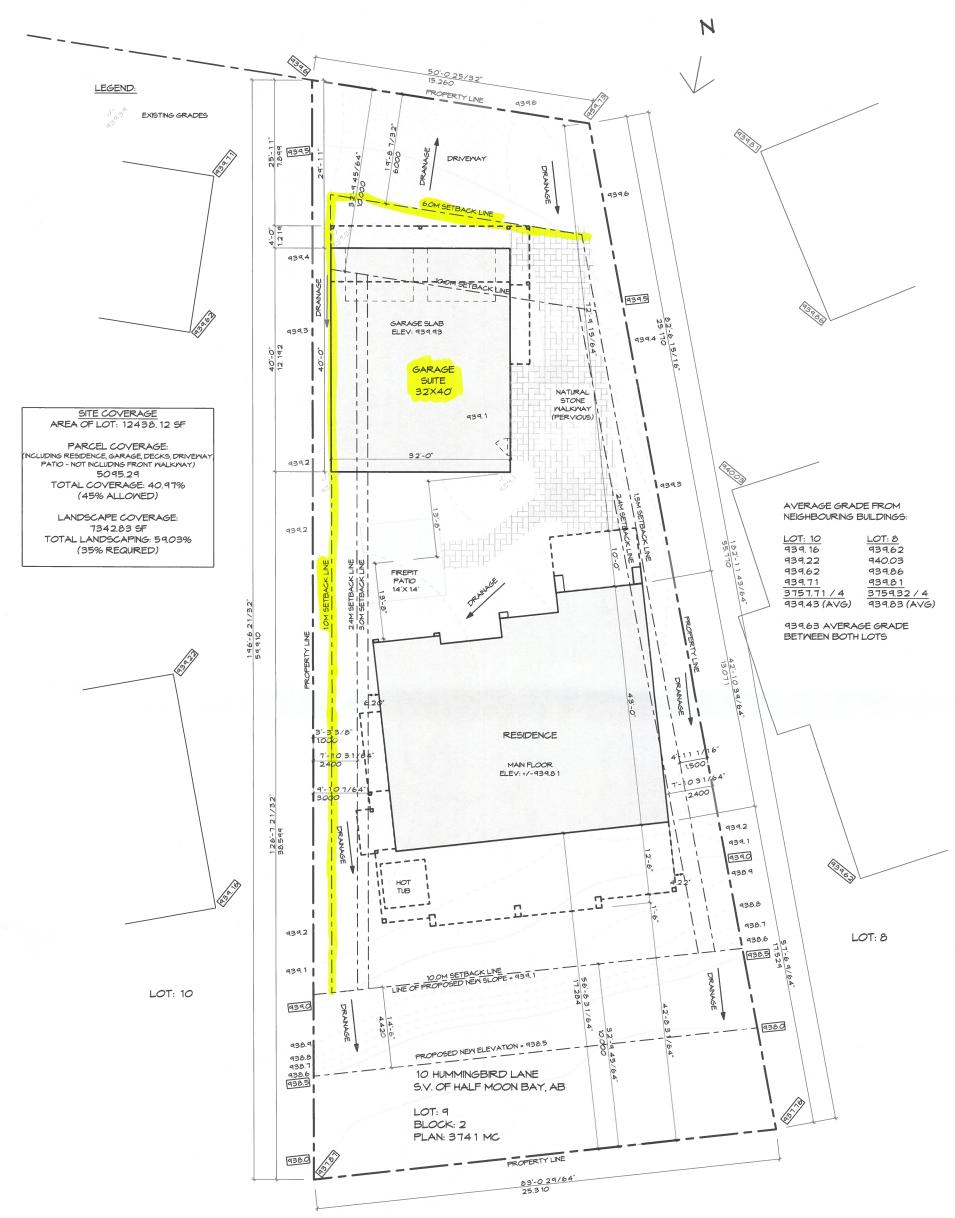THESE DRAWINGS MAY NOT BE USED OR DUPLICATED WITHOUT THE PERMISSION OF KD RESIDENTIAL DESIGN INC.

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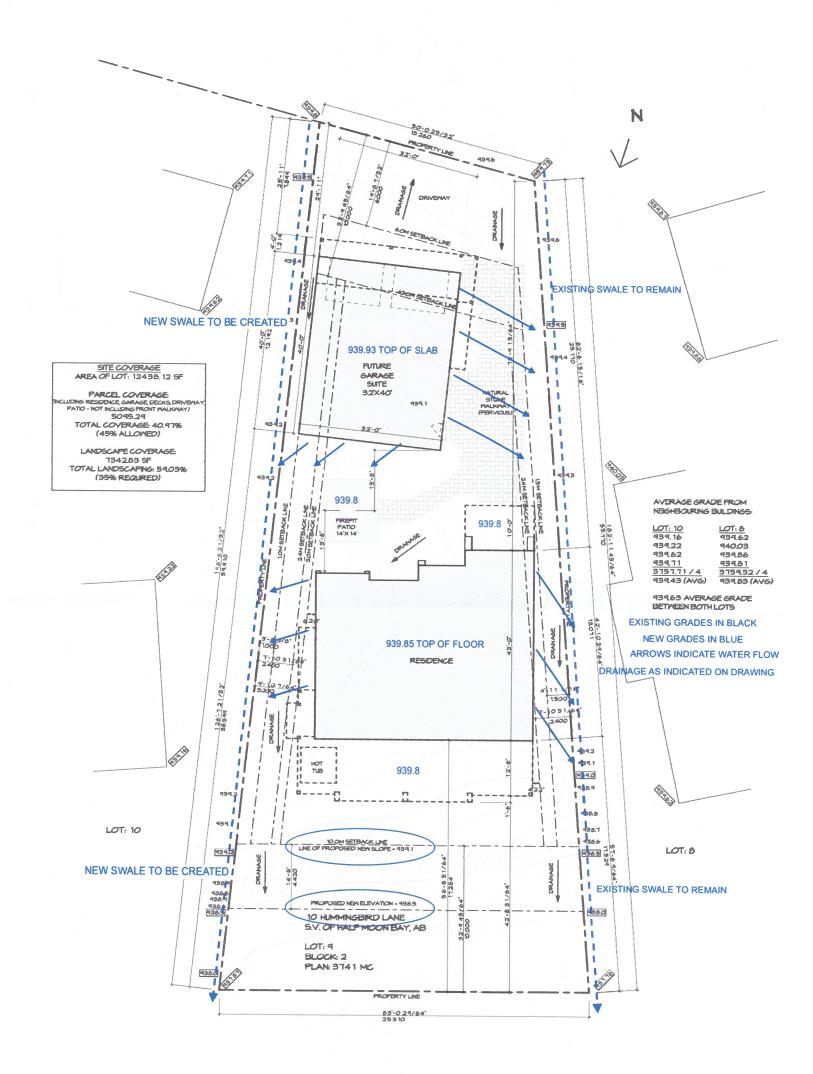
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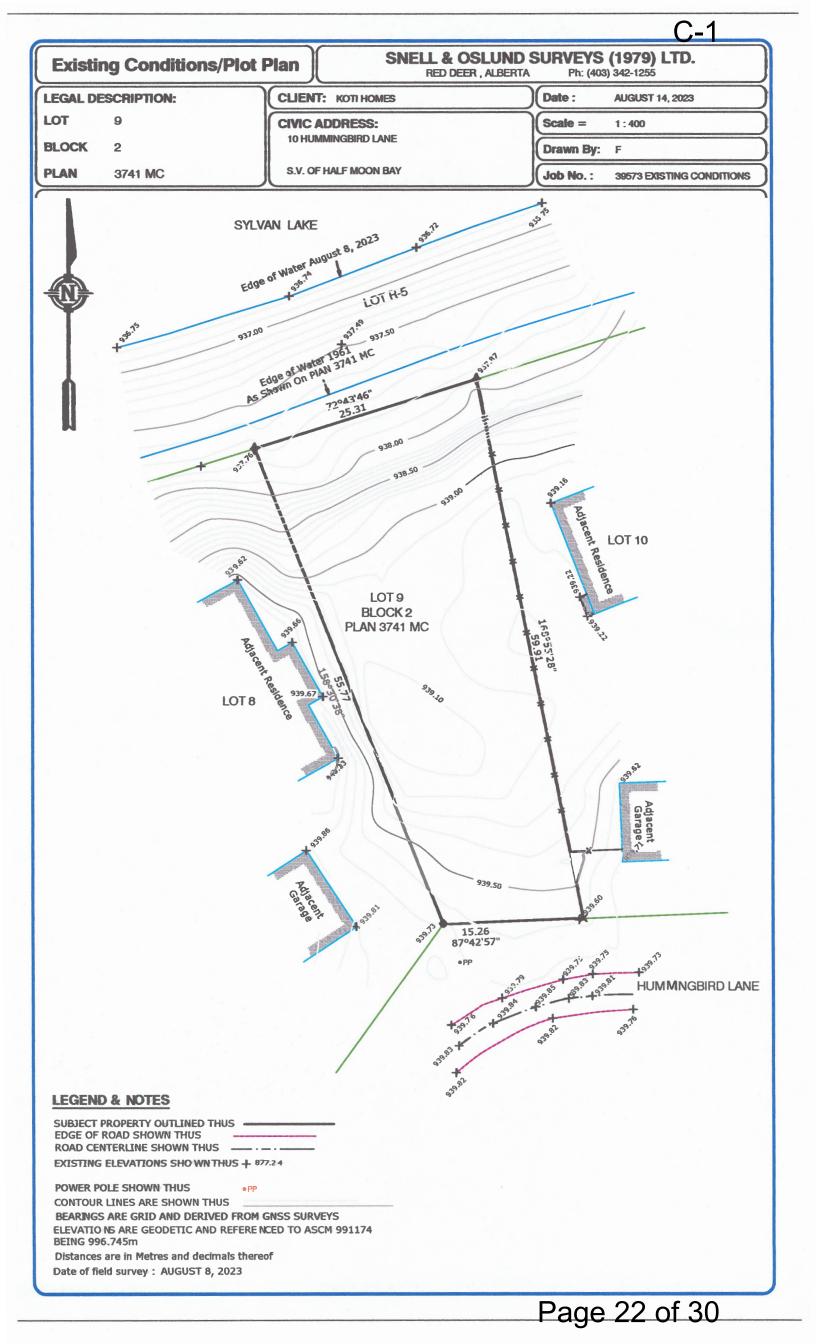
STE PLAN SCALE 1:200	
PROJECT NAME	PROJECT NUMBER: DATE
10 HUMMINGBIRD LANE	KO-2023-02 2023-10-30

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# STE PLAN SCALE 1:200 PROJECT NAME PROJECT NAMEER DATE NOTIHOMES KO-2023-02 2023-10-30 KOTIHOMES KD RESIDENTIAL

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Lot 9
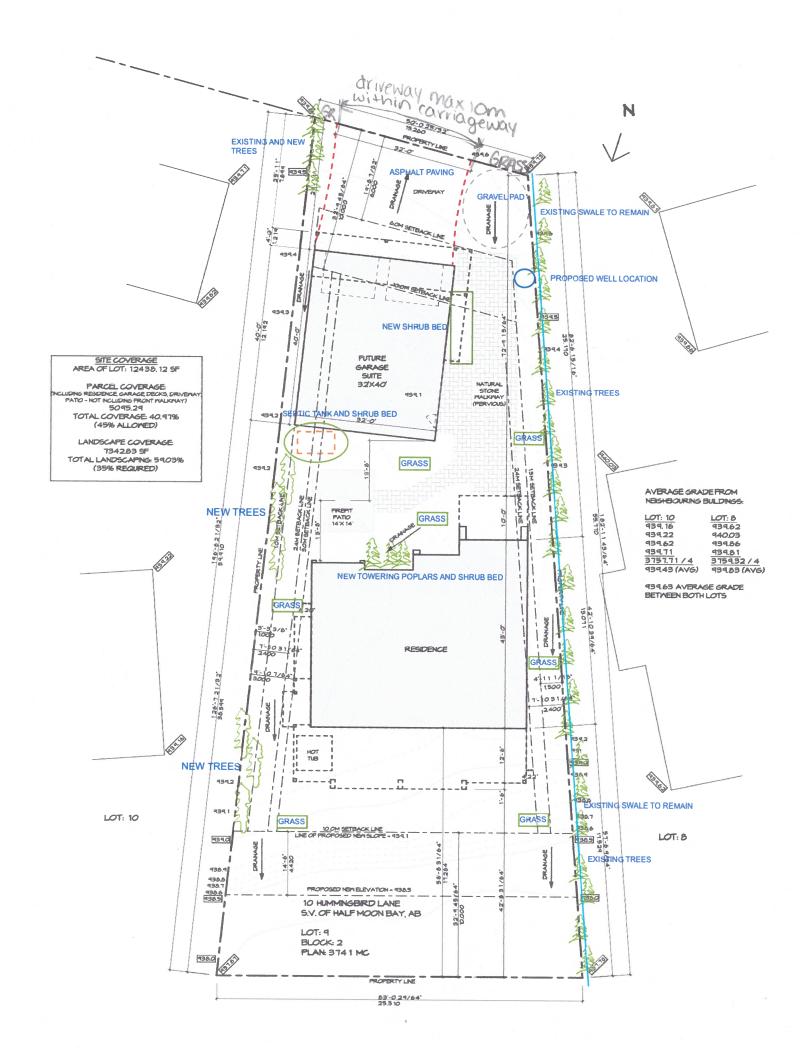
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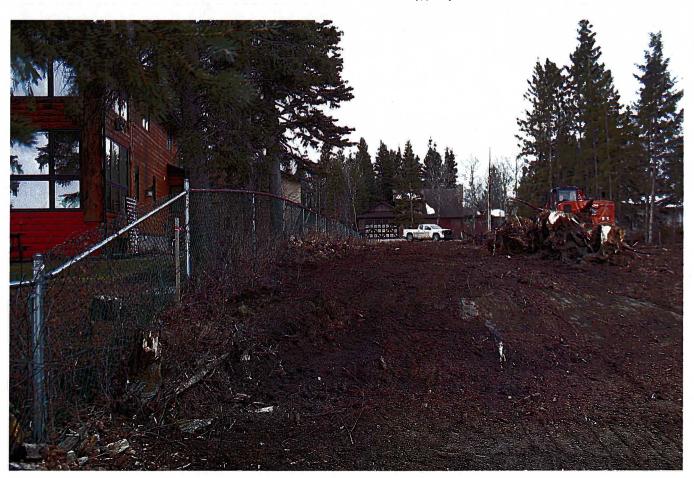
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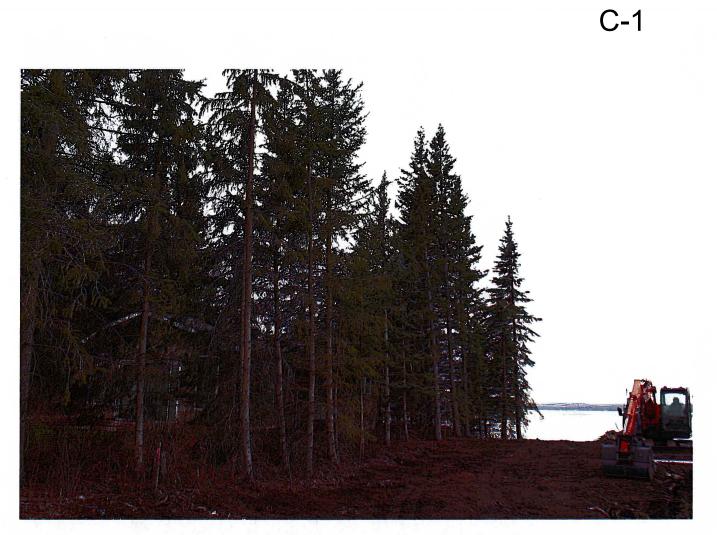
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## Summer Village of Half Moon Bay – Municipal Planning Commission

December 19, 2023

## Agenda Item

### 22 Hummingbird Lane (Lot 2, Block 2, Plan 3741MC)

### **Development Permit Application**

## Background:

In September 2023 a dwelling development permit was issued for the property at 22 Hummingbird Lane (Lot 2, Block 2, Plan 3741MC) in the village of Half Moon Bay. This property is located within the R District (Residential). This application before the Municipal Planning Commission today, has been applied for on behalf of the homeowner and is for a proposed garage with guest house on the property. The definition for guest house means "an accessory building containing sleeping facilities for temporary usage only and may have a bathroom but shall not have a kitchen or other cooking facilities. A guest house provides overflow accommodation for a detached dwelling located on the same parcel, is not available for rent by a third party, and does not include recreational vehicles and sea cans".

The proposed garage with guest house is within the setback requirements, within the maximum height, and when the dwelling permit was approved the landscaping and drainage plans were approved as well. The proposed detached garage is to be 1,260.45ft<sup>2</sup> and to be separate and subordinate to the main dwelling. The garage is intended to be used for storage with a guest house above. The parcel coverage for the property is proposed to be 38.9% and within the maximum 45%.


## **Discussion:**

This application is before MPC for the following reason:

- Land Use Bylaw, Part Four, Land Use District Uses: An accessory building where the total floor area is over 74m<sup>2</sup> (796.54ft<sup>2</sup>) is listed as a Discretionary Use. The proposed detached garage is 117.1m<sup>2</sup> (1,260.45ft<sup>2</sup>) therefore requires approval from the Municipal Planning Commission.
- Land Use Bylaw, Part Four, Land Use District Uses: Guest Houses are listed as a discretionary use, therefore requires approval from the Municipal Planning Commission.

## **Application Review:**

After reviewing the application and all relevant planning documents, administration does not see any reason for the board to deny the discretionary use as requested. The proposed garage with guest house does not require any variances and meets the

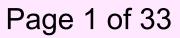

requirements of the Land Use Bylaw as mentioned above, given the definition of a "guest house".

### **Conditions:**

If approved, Administration would recommend the following conditions:

- Landscaping to be completed according to the landscaping plan. A minimum of 35% of the parcel shall be a landscaped area.
- All applicable Building, Electrical, and Plumbing & Gas permits shall be obtained with Superior Safety Codes.
- The height of the garage with guest house shall not exceed 7.62m (25ft.) in building height measured from grade.
- An accessory building erected or placed on a parcel shall not be used as a dwelling unit.
- Completions deposit of \$5,000.00.
- The exterior of an accessory building must be finished to match or compliment the exterior finish of the main building.
- "Guest House" means an accessory building containing sleeping facilities for temporary usage only and may have a bathroom but shall not have a kitchen or other cooking facilities.
- In situations where a detached dwelling is being rented out and there is a guest house on the parcel, the guest house shall not to be rented out to a separate party other than those renting the detached dwelling.
- A lot grade certificate is required to be submitted to the Development Authority at completion to ensure proper drainage on the property exists.
- A final as build real property report from an Alberta Land Surveyor at completion of landscaping to ensure parcel coverage is within the maximum and to verify heights are within the maximum.

## Authorities:

For a discretionary use in any district:

(a) The Municipal Planning Commission may approve an application for a Development Permit:

(i) With or without conditions;

(ii) Based on the merits of the proposed development, including its relationship to any approved statutory plan, non-statutory plan or approved policy affecting the site;

(iii) Where the proposed development conforms in every respect to this Land Use Bylaw; or

(b) The Municipal Planning Commission may refuse an application for a Development Permit based on the merits of the proposed development, even though it meets the requirements of this Land Use Bylaw; or

December 11, 2023


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(c) Subject to the provisions of section 2.4(2) the Municipal Planning Commission shall refuse an application for a Development Permit if the proposed development does not conform in every respect to this Land Use Bylaw.

### **Decision:**

In order to retain transparency of the Commission, Administration recommends one of the following:

- 1. Approve the application with or without conditions (Section 642 of the MGA), or
- 2. Deny the application stating reasons why (Section 642(4) of the MGA).

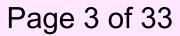

#### Kara Hubbard

From: Sent: To: Subject:

Follow Up Flag: Flag Status: Thursday, November 9, 2023 3:03 PM Kara Hubbard; Craig Callahan Garage/ guest bedroom, storage area

Follow up Flagged

#### Good afternoon,

We were advised that you a require letter explaining our needs for the building we would like to add to our property. Our intent for this structure, that will compliment our soon to be permanent residence, is needed for our personal use. It will be used to accommodate our pontoon boat that measures 39 feet in length on the trailer and 8 feet wide and 9.5 feet tall. The boat will take up half the space. I also have two vehicle lifts for storage of my collector vehicles; in the up position with a vehicle on them, 14 feet in height is required. When the lifts are in the up position, we will be able to park our daily drivers under the lifts. The remaining width in centre of building will be used to store our golf cart, side by side ATV, and lawn tractor. We also have wall shelving, a work bench, and tools and tool boxes. We have had the designer come up with engineered rafters that will accommodate a future bedroom and storage area. This structure's exterior and roof design will match the house. It will have a hardy board finish with matching decorative accents. We want to ensure our property adds to the aesthetics of Half Moon Bay and does not detract from it.


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Please feel free to contact us at any time with any questions or concerns.


#### Thank you.

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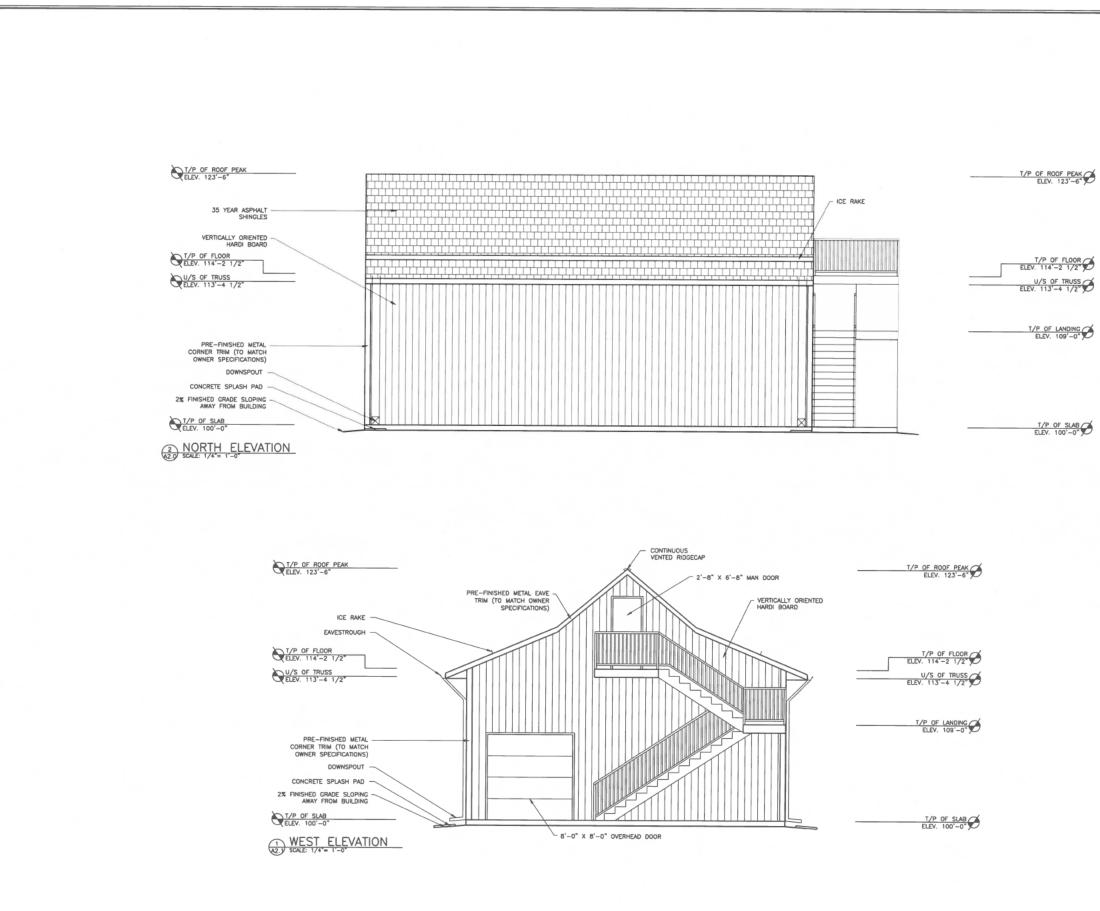
# <u>30'-0" X 42'-0"</u> <u>DETACHED GARAGE</u> <u>RED DEER COUNTY, ALBERTA</u>



BUILDING CODE ANALYSIS			FIRE SEPARATIONS:	ARTICLE:	PROVIDED:	DRAWING LIST			
BUILDING CLASSIFICATION:			FLOOR ASSEMBLIES	3.2.2.83 - 3/4HR FIRE RATED ASSEMBLY	3/4HR FIRE RATED ASSEMBLY				
MAJOR OCCUPANCY: GROUP F, DIVISION 3, UP TO 2 STOREYS 3.2.2.83 OTHER OCCUPANCIES: GROUP C, SINGLE FAMILY RESIDENCE					ROOF ASSEMBLIES	3.2.2.83 – 3/4HR FIRE RATED ASSEMBLY 3.2.2.83 – 3/4HR RATED OR N/C CONST. 3.2.2.83 – 3/4HR FIRE RATED ASSEMBLY	3/4HR FIRE RATED ASSEMBLY 3/4HR FIRE RATED ASSEMBLY 3/4HR FIRE RATED ASSEMBLY	00 - COVER PAGE A2.0 - BUILDING ELEV A2.1 - BUILDING ELEV A3.0 - MAIN FLOOR P	
DESCRIPTION:	ARTICLE:		PROVIDED:		SEPARATION OF SUITES	3.3.1.1 - NOT LESS THAN 1HR	3/4HR FIRE RATED	A3.1 - UPPER FLOOR P A5.0 - CONSTRUCTION A	
BUILDING ACCESS         3.2.2.10         FACING 1 STREET:           TOTAL MAIN FLOOR AREA         TABLE 3.2.2.83 <1600m <sup>8</sup> 117.06m <sup>4</sup> (1260f           TOTAL SCOND FLOOR AREA         TABLE 3.2.2.83 <0m <sup>8</sup> 31.22m <sup>4</sup> (336ft <sup>4</sup> )           MEZZANINE FLOOR AREA         TABLE 3.2.2.83 <0m <sup>8</sup> N/A		117.06m <sup>z</sup> (1260ft <sup>3</sup> ) 31.22m <sup>s</sup> (336ft <sup>3</sup> ) N/A NOT SPRINKLERED NOT REQUIRED	(23'-6") ITH ACCESS TO ALL SIDES	REPAIR CARAGE VEHICLE STORAGE FIREWALL BUILDING CONSTRUCTION MECHANICAL ROOM EXIT STARS JANITOR ROOM	3.3.5.5 (1) – 2HR FIRE RATED 3.3.5.6 (1) – 1HR FIRE RATED 3.1.10 – 4HR RATED CONC. BLOCK 3.2.2.83 – COMBUSTIBLE & N/C CONST. 3.6.2.1 – NOT LESS THAN 14MR RATED 3.4.4.1 – NOT LESS THAN 45MIN RATED 3.3.1.21 – NOT LESS THAN 45MIN RATED	N/A N/A COMBUSTIBLE & NON-COMBUSTIBLE N/A N/A	DOOR & WINDOW SCHEDI CALCULATIONS S1.0 - GENERAL NOTES S2.0 - FOUNDATION PLA S3.0 - BUILDING SECTIONS S4.0 - WALL SECTIONS S6.0 - TRUSS PLAN S7.0 - DETAILS		
WATER SUPPLY	3.2.5.7		OL REQUIRED		SPATIAL SEPARATIONS:	RATING/ALLOWABLE_OPENINGS:	PROVIDED:		
OCCUPANT LOAD FIRE ALARM EXIT SIGNS	TABLE 3.1.17.1 3.2.4.1 3.4.5.1	2.4.1 NOT REQUIRED			NORTH: SOUTH:	3/4HR FIRE RATING, 100% ALLOWED OPENINGS COMB. CLADDING & COMB. CONST. 3/4HR FIRE RATING, 100% ALLOWED OPENINGS	3/4HR FIRE RATING, 0% UNPROTECTED OPENINGS COMB. CLADDING & COMB. CONST. 3/4HR FIRE RATING, 10.27% UNPROTECTED OPENINGS		
REQUIRED PROFESSIONAL INVOLVEMENT			EAST: 3/4HR FIRE RATING	COMB. CLADDING & COMB. CONST. 3/4HR FIRE RATING, 100% ALLOWED OPENINGS COMB. CLADDING & COMB. CONST.	COMB. CLADDING & COMB. CONST. 3/4HR FIRE RATING, 54.06% UNPROTECTED OPENINGS COMB. CLADDING & COMB. CONST.				
ARCHITECTURAL:	STRUCTURAL:	MECHANICAL:	ELECTRICAL:	GEOTECHNICAL:	WEST:	3/4HR FIRE RATING, 100% ALLOWED OPENINGS	3/4HR FIRE RATING, 15.96% UNPROTECTED OPENINGS		
RICHARDS CONSULTING	RICHARDS CONSULTING	##	##	##		COMB. CLADDING & COMB. CONST.	COMB. CLADDING & COMB. CONST.		

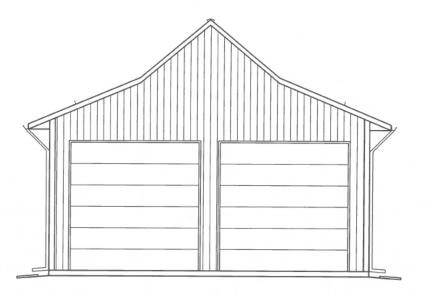


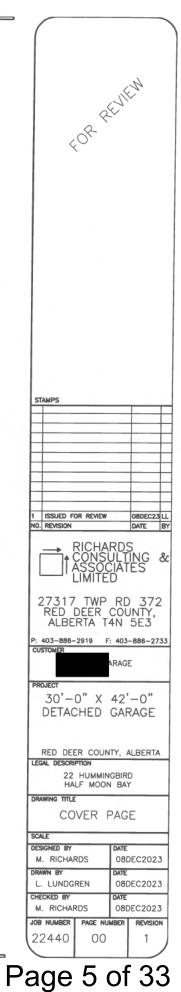
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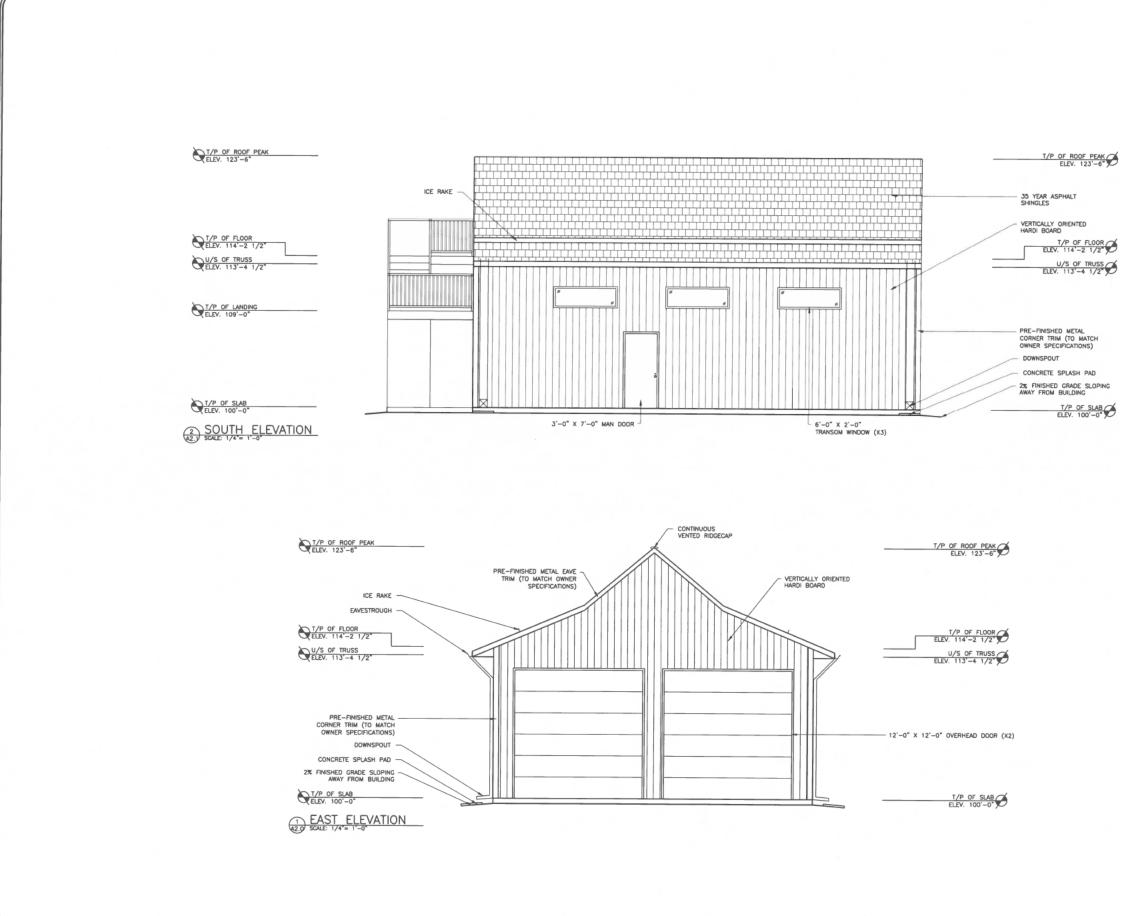
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FOR	EVIEN
STAMPS	
1 ISSUED FOR REVIEW	OBDEC23LL DATE BY
	RDS JLTING & D RD 372
27317 TWP RED DEER ALBERTA T P: 403-886-2919 F CUSTOMER	
PROJECT 30'-0" X DETACHED	42'—0" GARAGE
RED DEER COUN LEGAL DESCRIPTION 22 HUMMIN HALF MOON	GBIRD
DRAWING TITLE BUILDI ELEVATI SCALE DESIGNED BY	
M. RICHARDS DRAWN BY L. LUNDGREN CHECKED BY	08DEC2023 DATE 08DEC2023 DATE
M. RICHARDS	08DEC2023
22440 A2.0	







## Page 7 of 33

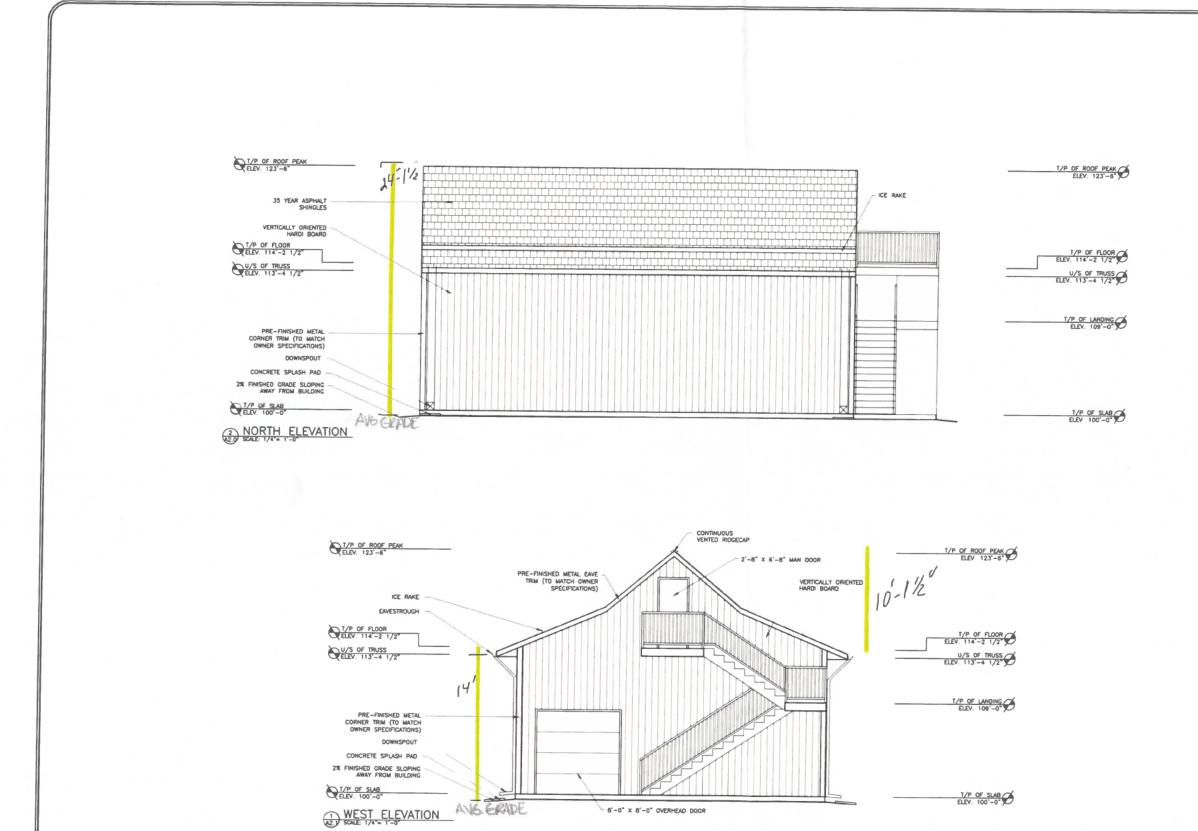

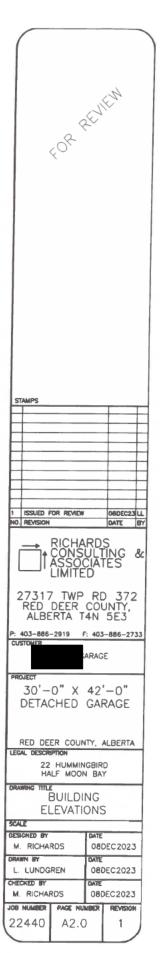
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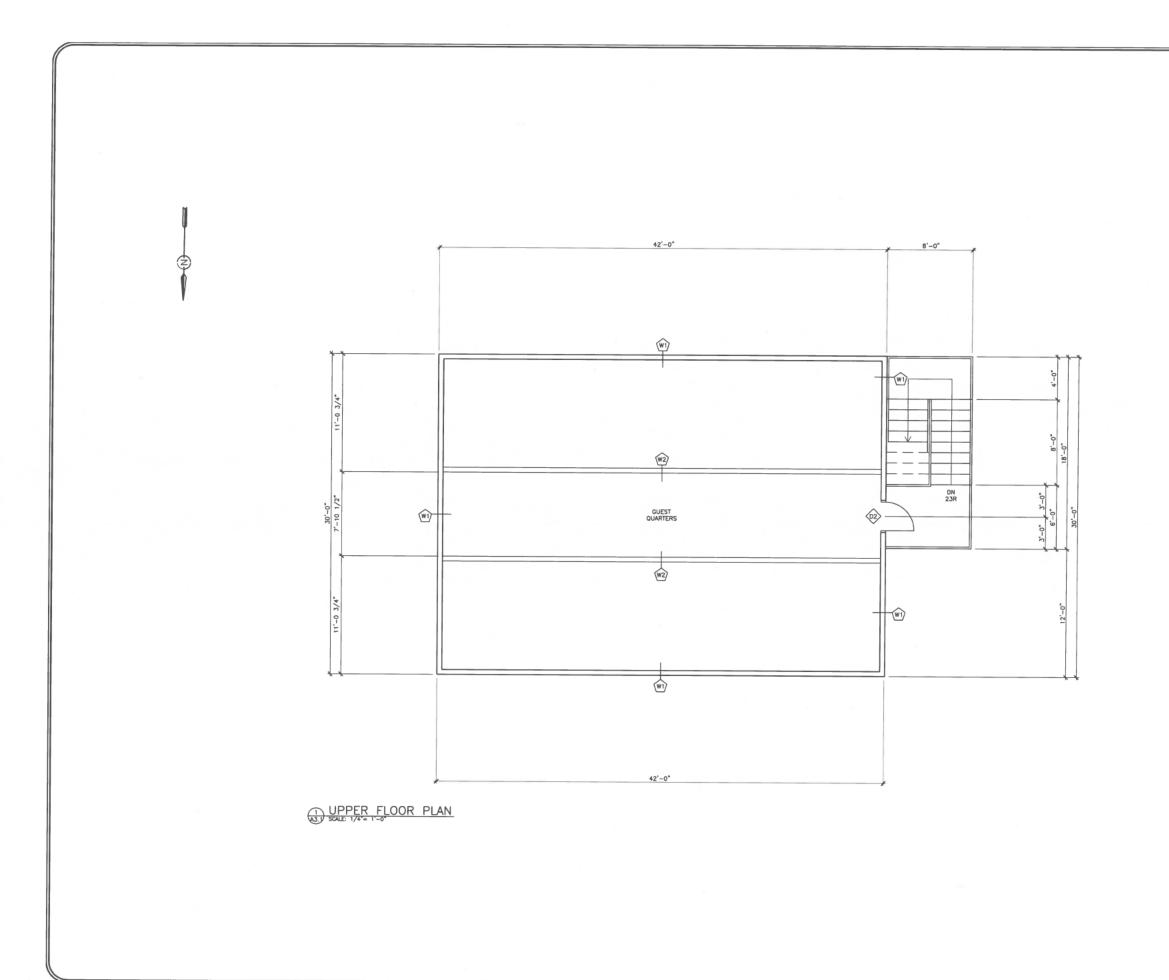


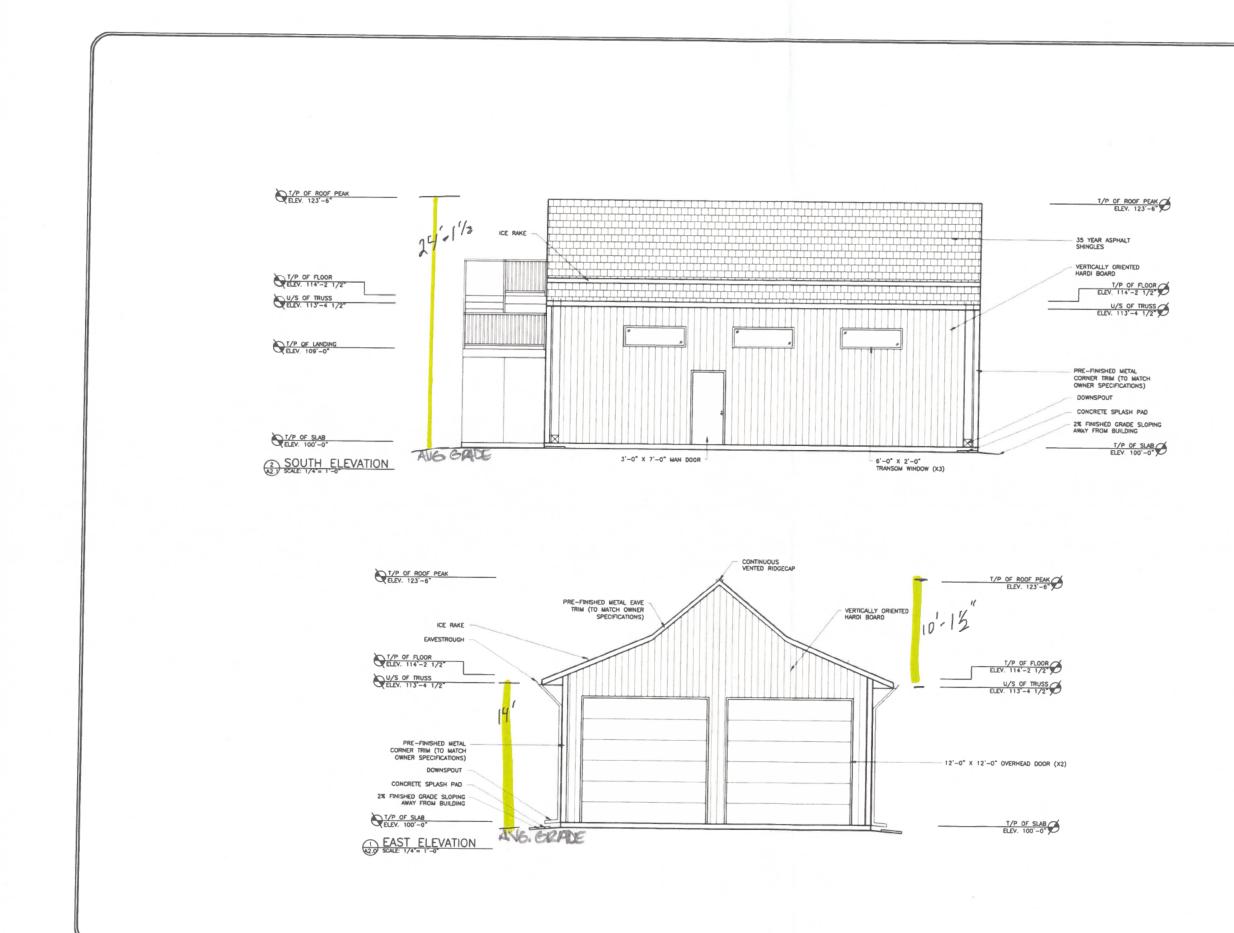


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	ROOF DESCRIPTION:	
(R1		~~~~~~~~~~~~~~~~~~~~~~~~~~~~~~~~~~~~~~
	- 35 YEAR OLD ASPHALT SHINGLES	W) I
	- ROOFING PAPER	
	<ul> <li>ICE AND WATER SHIELD EXTEND 36" UP FROM EAVE</li> </ul>	
	- 1/2" SPF NO 1/2 PLYWOOD, SECURE IN PLACE WITH 3" C.W.N. AT 6" O.C. ON SHEET	-
	PERIMETER AND 12" O.C. FLSEWHERE	-
	- ENGINEERED TRUSS @ 24" O.C. SEE MANUFACTURER'S DRAWINGS FOR PERMANENT	-
	AND TEMPORARY CROSS BRACING	-
	- PERMANENT TRUSS BRACING PLACE 1-2X4 SPF NO 1/2 CENTERED ON TRUSS	_
	COMPRESSION WEB EACH SIDE OF CENTER	~ -
	COMPRESSION WEB FULL LENGTH OF BUILDING C/W DIAGONAL 2X4 SPF NO 1/2 BRACE NAILED	<u>wa</u> 2
	TO WEB @ APPROX 20'-0" INTERVALS	
	- FASTEN ALL TRUSS ENDS WITH MIN OF 4 5/16"X4" RSS FASTENERS 2 ON EACH SIDE	
	<ul> <li>R50 BLOWN IN INSULATION</li> <li>6 MIL POLYETHYLENE VAPOUR BARRIER</li> <li>1 LAYER OF 5/8" TYPE "X" GYPSUM WALL</li> </ul>	(i) II
	- 1 LAYER OF 5/8" TYPE "X" GYPSUM WALL BOARD TAPED AND FINISHED	- 69
		-
R2	ROOF EAVE CONSTRUCTION	-
	<ul> <li>– 35 YEAR OLD ASPHALT SHINGLES</li> <li>– ROOFING PAPER</li> </ul>	-
	- ICE AND WATER SHIELD EXTEND 36" UP FROM EAVE	
	- 1/2" SPE NO 1/2 PLYWOOD SECURE IN	$\sim^{1}$
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	- ENGINEERED TRUSS @ 24" O.C. SEE	_
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-	<ul> <li>35 YEAR OLD ASPHALT SHINGLES</li> <li>ROOFING PAPER</li> </ul>	0
	<ul> <li>ICE AND WATER SHIELD EXTEND 36" UP</li> </ul>	-
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	PLACE WITH 3" C.W.N. AT 6" O.C. ON SHEET	3
	PERIMETER AND 12" O.C. ELSEWHERE - ENGINEERED TRUSS @ 24" O.C. SEE	T) 98
	MANUFACTURER'S DRAWINGS FOR PERMANENT AND TEMPORARY CROSS BRACING	F2 G
	<ul> <li>PERMANENT TRUSS BRACING PLACE 1-2X4</li> </ul>	9
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	COMPRESSION WEB FULL LENGTH OF BUILDING C/W DIAGONAL 2X4 SPF NO 1/2 BRACE NAILED	SH
	TO WEB C APPROX 20'-0" INTERVALS	-
	- 5" OF 3LB DENSITY CLOSED CELL URETHANE INSULATION	A
	– 6 MIL POLYETHYLENE VAPOUR BARRIER	Až
	- 1 LAYER OF 5/8" TYPE "X" GYPSUM WALL BOARD TAPED AND FINISHED	
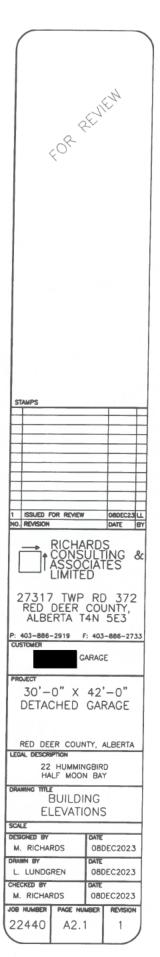
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	QT	MARK	SIZE				LOCATION	STYLE		DOOR	SL	AB		_	_		F	RAM	Ε			HA	RDW	VAR	E		
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UNITS ALUMINUM FRAMES FRAME COLOR - BY OWNER	1	D1	3'-0" X 7'-0"	•			EXTERIOR MAN DOOR	MAN							•						,	•	•				
CONFIRM STYLE WITH OWNER MINIMUM U VALUE ( $W/m^* \times K$ ) = 1.60 MINIMUM RSI VALUE ( $m^* \times K/W$ ) = 0.625 MINIMUM ENERGY RATING (ER) = 25	1		2'-8" X 6'-8"	•			EXTERIOR MAN DOOR	MAN							•		1.		$\square$		,	•	•	$\square$			
MINIMUM U VALUE $(W/m^* \times K) = 1.60$	1		2'-6" X 6'-8"	•			INTERIOR MAN DOOR	MAN	•			1			•		1.		$\square$		,	•		•			
MINIMUM KSI VALUE $(m^2 \times K/W) = 0.625$	2		12'-0" X 12'-0"		•		OVERHEAD DOOR	0/H							•		1.				,	•		$\neg$	$\square$		
minimum circitor rothing (EK) = 20	1	05	8'-0" X 8'-0"		•		OVERHEAD DOOR	0/H							•				$\square$					$ \rightarrow $			
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WALL DESCRIPTION:	(			
BUILDING EXTERIOR WALLS				
- VERTICALLY ORIENTED HARDI BOARD - BUILDING PAPER				
- 1/2" PLYWOOD SHEATHING - 2:2X6 SPF NO 1 WALL TOP PLATES		8 F		4
- 2X6 SPF NO 2 STUDS AT 16" O.C. - 2X6 SPF NO 2 MIDSPAN BLOCKING - 2X6 PRESSURE TREATED BASE PLATE				
- 5/8"X8"X3" A36 ANCHOR BOLTS PLACED AT 32"		6	$\sim$	
0.C., ALL BOLTS TO C/W CUT WASHERS - R22 ROCKWOOL INSULATION - 6 MIL POLY VAPOR BARRIER		25	-	
- 1 LAVER OF 5/8" TYPE "X" GYPSUM WALL BOARD - INTERIOR FINISH BY OWNER	6	07		
GUEST QUARTERS ATTIC WALLS	X			
- 1 LAYER OF 5/8" TYPE "X" GYPSUM WALL BOARD - 2X6 TRUSS WEBBING				
<ul> <li>- 5" OF JLB DENSITY CLOSED CELL URETHANE INSULATION</li> <li>- 1 LAYER OF 5/8" TYPE "X" GYPSUM WALL BOARD</li> </ul>				
INTERIOR PARTITION WALL - 3" DRYWALL, MOISTURE PROOF ON WASHROOM SIDE				
- 2:2X6 SPF NO 1 TOP PLATES - 2X6 SPF NO 1 WALL STUDS AT 16" O.C.				
- 2X6 SPF NO 2 MALL STODS AT TO U.C. - 2X6 SPF NO 2 BOTTOM PLATE - R20 BATT INSULATION				
- ½" DRYWALL				
FLOOR DESCRIPTION:				
CONCRETE SLAB CONSTRUCTION - SURFACE HARDENER AND COLOUR BY OWNER				
- 5" THK. CONCRETE STRUCTURAL SLAB r/w 15M BAR REINFORCING © 16" 0.C. E/W				
CONCRETE TO BE 32 MPg 28 DAY COMPRESSIVE STRENGTH (TYPE 10 PORTLAND				
CEMENT) - CONTROL JOINTS SPACED @ 20'-0" O.C.				
E/W FILL CONTROL JOINTS WITH ELASTOMERIC SEALANT				
- 6 mil POLY VAPOUR BARRIER - 6" THK. OF 3/4" CRUSHED ROCK COMPACTED TO 98% PROCTOR DENSITY DROCE DOLL JUE FUTURE COLOR TO				
ENSURE ALL LOW BEARING SOILS ARE DETECTED & REMOVED-PROOF ROLL SUBGRADE ONLY ONCE TO AVOID WEAKENING SOIL BEARING				
STRENGTH. - EXCAVATE LOW BEARING SOILS AREAS TO A	STAMPS			
MIN. DEPTH OF 24" AND REPLACE WITH ONE LAYER OF GEOTEXTILE MATERIAL AND FILL WITH				
3" MINUS PIT RUN IN LIFTS NO GREATER THAN 6" WITH EACH LIFT BEING COMPACTED TO				
98% PROCTOR DENSITY GUEST QUARTERS FLOOR CONSTRUCTION				
- FLOOR FINISH BY OWNER				
- 3/4" T&G S.P.F. PLYWOOD SECURED IN PLACE WITH ∯10 1 1/2" SCREWS @ 8" O.C. SHEET PERIMETER & 12" ELSEWHERE				
- 2X6 TRUSS BOTTOM CORD - R22 ROCKWOOL INSULATION				
- 1 LAYER OF 5/8" TYPE 'X' DRYWALL TAPED AND FINISHED				
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#### STRUCTURAL TIMBER:

1) ALL WOOD MEMBERS TO BE S.P.F. No. 1/2 UNLESS OTHERWISE NOTED

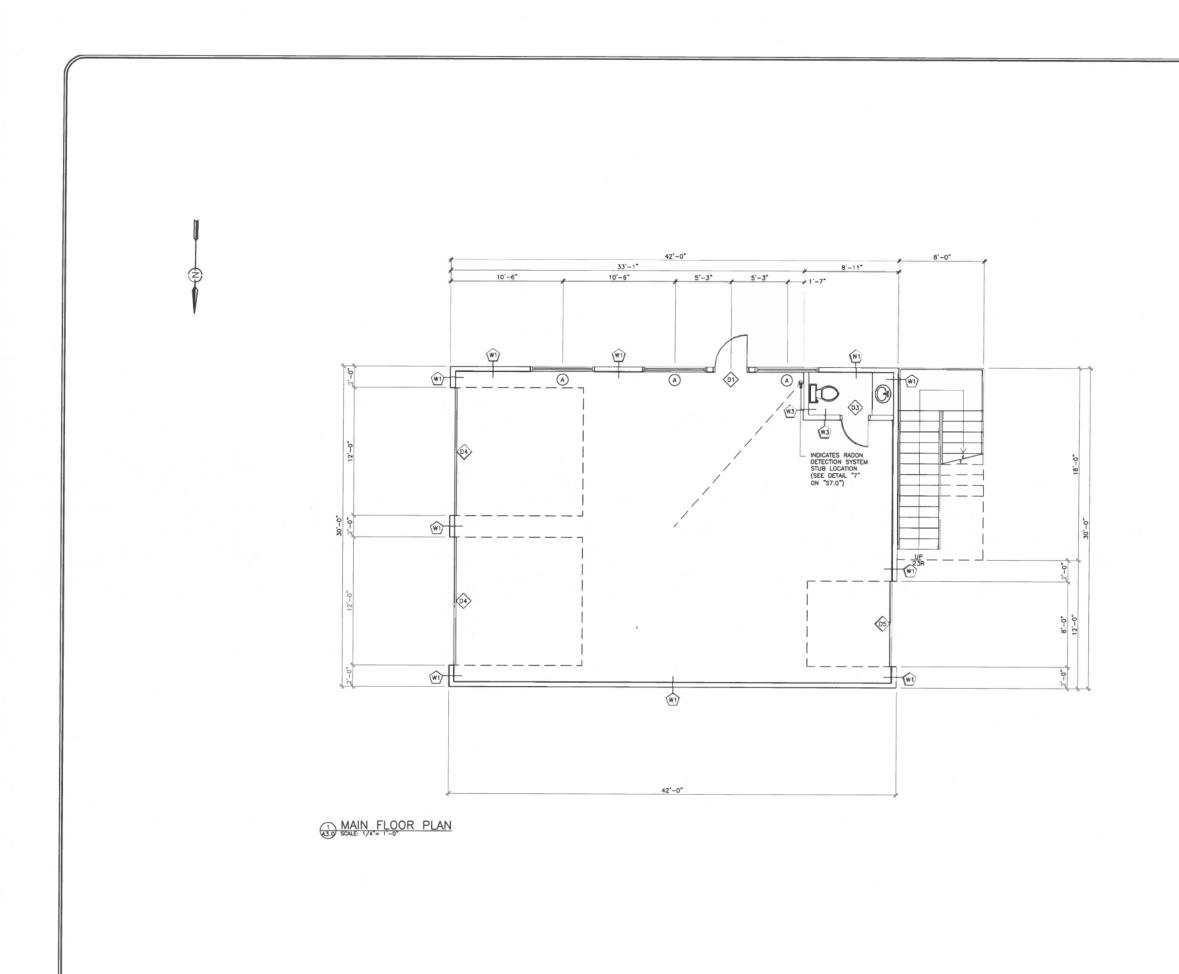2)ALL WOOD MEMBER TO CONFORM TO CAN/CSA 086.1-94 3)ALL BUILT UP WOOD BEAMS AND SCL TECLAM BEAMS TO HAVE A MIN OF 1 1/2 END

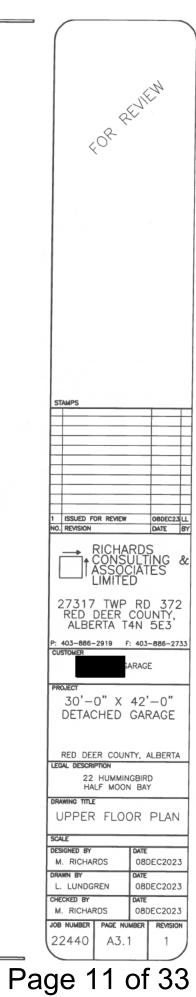BEARING UNLESS OTHERWISE NOTED 4)ALL MEMBER SHALL BE SO FRAMED, ANCHORED, TIED AND BRACED TOGETHER AS TO

PROMDE THE STRENGTH AND RIGIDITY NECESSARY FOR THE PURPOSE FOR WHICH THEY ARE DESIGNED 5)WHEN CONDITIONS CONDUCIVE TO DECAY OR OTHER DETERIORATION ARE LIKELY TO OCCUR

JIMHEN CONDITIONS CONDUCVE TO BEAY OR OTHER DETERIORATION ARE LIKELY TO OCCUR IN THE CASE OF PERMANENT STRUCTURES, WOOD SHOULD BE PRESSURE-TREATED WITH PRESERVATIVE IN ACCORDANCE WITH THE REDUIREMENTS OF CSA STANDARD CAN/CSA-080 SERIES. IF POSSIBLE ALL BORING, GROOVING, CUTTING AND OTHER FABRICATION SHOULD BE COMPLETED BEFORE TREATMENT. FABRICATION CARRIED OUT AFTER TREATMENT SHALL BE TREATED LOCALLY IN ACCORDANCE WITH CSA STANDARD CAN/CSA-080 SERIES.

6)UNTREATED WOOD IN PERMANENT STRUCTURES SHALL NOT BE IN DIRECT CONTACT WITH MASONRY, CONCRETE, OR SOIL WHERE MOISTURE TRANSFER CAN OCCUR.

7)LUMBER USED SHALL BE IDENTIFIED BY THE GRADE STAMP OF AN ASSOCIATION OR INDEPENDENT GRADING AGENCY IN ACCORDANCE WITH THE PROVISIONS OF CSA STANDARD

CAN/CSA-0141 8)CANADIAN SPECIES ARE DESIGNATED ACCORDING TO SPECIES COMBINATIONS SUCH AS S.P.F. (SPRUCE, PINE OR FIR)

9)FINGER JOINED LUMBER SHALL BE PRODUCED AND GRADE STAMPED IN ACCORDANCE WITH

NLGA SPECIAL PRODUCT STANDARD SPS1. 10) IN THE CASE OF NAILED BUILT-UP COMPRESSION MEMBERS (COLUMNS) ALL NAILS SHALL

UDIN THE CASE OF NALED BUILT-UP COMPRESSION MEMBERS (COLUMNS) ALL NALES SHALL PENETRATE THROUGH AT LEAST 3/4 OF THE THICKNESS OF THE LAST INDMDUAL PIECE AND NALES SHALL BE DRIVEN ALTERNATELY FROM EITHER FACE OF THE BUILT-UP MEMBER ALONG THE LENGTH. WHEN INDMDUAL PIECES OF THE BUILT-UP MEMBER ARE WIDER THAN 3 TIMES THER THICKNESS, THERE SHALL BE AT LEAST 2 ROWS OF NALLS ACROSS THE MEMBER WIDTH.

11) IN THE CASE OF BOLTED BUILT-UP COMPRESSION MEMBERS THE INDIVIDUAL PIECES OF THE BUILT-UP MEMBER ARE WIDER THAN 3 TIMES THEIR THICKNESS, THERE SHALL BE AT LEAST 3 ROWS OF BOLTS ACROSS THE MEMBER WIDTH.

12) SPLICED BUILT-UP COMPRESSIVE MEMBERS SHALL CONSIST OF A MIN OF 3 MEMBERS, WITH NAILS PENETRATING ALL 3 MEMBERS, THE MIN OVERALL SPLICE LENGTH SHALL BE 1200mm (3'-11 1/4') SPUCED COLUMNS SHALL BE BRACED BY SHEATHING OR PURLINS SPACED AT A MAX OF GOOMM(1'-11 \$6') OC in the direction perpendicular to the the transmission of the Wide Face of the LAMINATIONS. THE MIN LAMINATION SIZE SHALL BE 38mm X 1 (2X6) AND THE MAX SHALL BE 38mm X 184mm (2X8)

13) IF PRESERVED WOOD FOUNDATIONS ARE USED ALL LUMBER AND PLYWOOD SHALL BE

TREATED IN ACCORDANCE WITH CSA STANDARD CAN/CSA-080.1S EXCEPT WHERE EXEMPTED FROM TREATMENT BY CSA STANDARD CAN/CSA-5406 14) THE NATIONAL BUILDING CODE PART 4 STATES THAT GLUED-LAMINATED TIMBER BE

FABRICATED IN PLANTS CONFORMING TO CSA STANDARD CAN/CSA-0177 15) PLYWOOD USE FOR STRUCTURAL PANELS - REGULAR GRADES OF LINSANDED D.FIR

I)PLW000 USE FOR STRUCTURAL PARELS - REGULAR GRADES OF URSARRED U.FIR PLW000 MANUFACTURED AND IDENTIFIED IN ACCORDANCE WITH CSA STANDARD 0121 AND TO STANDARD CONSTRUCTION OF REGULAR GRADES OF UNSANDED CANADIAN SOFTWOOD PLYWOOD MANUFACTURE'S AND IDENTIFIED IN ACCORDANCE WITH CSA STANDARD 0151

16) O.S.B. SHEATHING USED AS STRUCTURAL PANELS SHALL BE OF TYPES 1,2 AND 3 THAT ARE QUALIFIED AND CERTIFIED FOR ENGINEERING USES, AND IDENTIFIED IN ACCORDANCE WITH CSA STANDARD 0452.0 MAY BE USED.

17) ADHESIVES FOR STRESS JOINTS FOR STRUCTURAL PANELS SHALL MEET THE REQUIREMENTS OF CSA STANDARD 0112.7

18) SHEAR PANELS USING PLYWOOD O.S.B. OR WAFERBOARD SHALL BE CONSTRUCTED WITH 18) SHEAR PANELS USING PLYMOOD 0.5.B, OR WAFERBOARD SHALL BE CONSTRUCTED WITH PANELS NOT LESS THAN 1200mm X 24 000mm (48 X 96). EXCEPT NEAR BOUNDARIES AND CHANGES IN FRAMING WHERE UP TO 2 SHORT OR NARROW PANELS MAY BE USED. FRAMING MEMBERS SHALL BE PROVIDED AT THE EGGE OF ALL PANELS IN SHEAR WALLS. 19) THE NALLS AND SPACING OF NAILS AT SHEAR PANEL BOUNDARIES AND THE EGGES OF EACH PANEL SHALL BE DONE WITH NAILS OF THE SAME SIZE PLACED ALONG ALL STRUMENT OF THE SHALL BE DONE WITH NAILS OF THE SAME SIZE PLACED ALONG ALL INTERMEDIATE FRAMING MEMBERS AT 250mm (10') 0/C FOR FLOORS, 300mm (12') 0/C FOR ROOFS AND 300mm (12) O/C FOR WALLS UNLESS OTHERWISE NOTED ON THE DRAWINGS: EXCEPT THAT THE NAIL SPACINGS SHALL BE 150mm (5) O/C FOR WALLS OF 9.5mm (3/8") PANELS INSTALLED WITH THE FACE GRAIN PARALLEL TO THE STUDS, AND THE

STUDS SHALL BE SPACED 600mm (24') O/C OR LESS. UNLESS INDICATED OTHERWISE ON THE DRAN

20) UNLESS NOTED OTHERWISE ALL LUMBER SHALL BE S.P.F. No. 1/2 MEMBERS

21)RICHARDS CONSULTING AND ASSOCIATES SHALL NOT ASSUME ANY LIABILITY FOR THE ENGINEERED COMPONENTS (TRUSSES, JOISTS) DESIGNED BY OTHERS WHICH ARE USED ON THIS PROJECT.

#### GENERAL STRUCTURAL NOTES:

1) DRAWINGS ARE TO BE READ AND NOT SCALED.

2)ALL DIMENSIONS ARE TO BE VERIFIED WITH THE ARCH. & MECH DRAWINGS PRIOR TO CONSTRUCTION & EACH SUB TRADE IS RESPONSIBLE FOR VERIFYING DIMENSION IN THE FIFLD 3)DESIGN LOADS:

Ss = 43.91psf

Sr = 2.09psf Qr/50 = 9.40psf UPPER FLOOR:

L.L. = TBD D.L. = TBD

#### CONCRETE SCHEDULE

CONCRETE STRUCTURE	S	TRE	NGTH			ANI NT		ε		GRE AX.)	GAT	E	o	ΓHE	RS		
	32 mPa	35 mPa		10	20	30	40	50	1/2"	3/4"			AIR ENTRAINMENT	SLUMP	SUPER PLASTICIZER	HARDENER	SEAL FD
INTERIOR SLABS														4"			
EXTERIOR SLABS														4*			
GRADE BEAM								٠		٠				4"			
PILES								٠		٠		_		4"	_		
																	Г

#### CONCRETE:

1)ALL CONCRETE IS TO BE MANUFACTORED AND INSTALLED IN ACCORDANCE WITH THE LATEST EDITION OF CAN3-CSA A23.1 "METHOD OF TEST FOR CONCRETE" 2)SEE CONCRETE SCHEDULE FOR ALL CONCRETE MIN BEARING STRENGTH AT 28 DAYS

3)ALL CONCRETE TO HAVE NO LARGER THAN 3/4" AGGREGATE. (SEE CONCRETE SCHEDULE)

4)AIR ENTRAINING ADMIXTURES SHALL CONFORM TO THE REQUIREMENTS OF CAN3-4266.1 AIR-ENTRAINING ADMIXTURES FOR CONCRETE, CSA CAN3-A266.2 "CHEMICAL ADMIXTURES FOR CONCRETE", CSA CAN3-A266.4 "GUIDLINES FOR THE USE OF ADMIXTURES IN CONCRETE", CSA CAN3-A266.6 "SUPERPLASTICIZING ADMIXTURES FOR CONCRETE", AND CSA CAN3-A266.5 "GUIDELINES FOR THE USE OF SUPERPLASTICIZING ADMIXTURES FOR CONCRETE (SEE CONCRETE SCHEDULE)

5)CONCRETE TO HAVE 4 SUMP

6)USE OF A SUPER PLASTICIZER ADMIXTURE IS REQUIRED TO AID IN WORKABLITY AND TO ENHANCE CONCRETE STRENGTH AS PER CONCRETE SCHEDULE. 7)SURFACE HARDENER & SEALER IS REQUIRED AS PER CONCRETE SCHEDULE.

8)ALL CONCRETE TO BE TYPE 10 PORTLAND CEMENT (SEE CONCRETE SCHEDULE)

#### FORM WORK:

1) A LAYER OF 6 mil POLY SHALL BE PLACED UNDER ALL CONCRETE SLABS ON GRADE OR

2)ACCESSORIES SUCH AS HI-CHAIRS, SPACERS, ETC. SHALL BE SUPPORTED BY PADS OF PLYWOOD OR TEMPERED HARDBOARD TO PREVENT PUNCTURING THE POLY

3)ALL PAVING OR CONCRETE SLABS ON GRADE AGAINST STRUCTURAL MEMBERS SHALL HAVE A 1/2 SPACER, USING FIBERBOARD, TREATED WOOD, ASPHALT IMPREGNATED FIBERBOARD, ETC.

#### FOUNDATIONS:

1)A GEOTECHNICAL REPORT SHOULD BE PERFORMED AND BE AVAILABLE FOR REVIEW 2)THE FOUNDATION CONTRACTOR SHALL SATISFY HIMSELF AS TO THE PREVAIUG CONDITIONS AT THE SITE AS NO EXTRAS SHALL BE GRANTED SHOULD THE CONDITIONS DIFFER FROM THOSE

#### SOIL BEARING NOTES:

MIN ALLOWABLE SOIL BEARING STRENGTH TO BE 3000 paf. THIS MUST BE SITE CONFIRMED PRIOR TO PLACING ANY CONCRETE PADS. NOTIFY RICHARDS CONSULTING & ASSOCIATES LTD. WHEN HOLES ARE BEING GRILLED

#### CONCRETE SLAB CONSTRUCTION NOTES:

ALL CONCRETE TO BE MIN. 3,200 psi, 28 DAY TEST BEARING STRENGTH. REFER TO CONCRETE

FLOOR SLAB TO BE SAWN @ 20'-0" O.C. INTERVALS EACH WAY TO PROVIDE TEMPERATURE CONTROL JOINTS

SUB GRADE TO BE EXCAVATED UNTIL A GOOD CLAY BASE IS AVAILABLE. SUB GRADE TO BE PROOF ROLLED UNTIL A MIN SOIL COMPACTION OF 95% PROCTOR DENSITY IS ACHIEVED. IF FILL MATERIAL IS REQUIRED, USE 2"-3"6 CLEAN PIT RUN PLACED IN LIFTS NO GREATER THAN 6" COMPACTED TO 95% PROCTOR DENSITY

#### REINFORCING STEEL:

- 1)ALL REINFORCING STEEL TO BE CSA G30,18M 400 mPa, EXCEPT COLUMN TIES AND BEAM STIRRUPS WHICH MAY BE 60,000 psi GRADE STEEL
- 2)ALL REINFORCING IS TO BE DETAILED IN ACCORDANCE WITH THE LATEST EDITION OF THE ACI DETAILING MANUAL, EXCEPT OTHERWISE NOTED.
- 3)REINFORCING STEEL COVER IS TO CONFORM TO THE LATEST EDITION OF CSA CAN3-A23.3 "DESIGN OF CONCRETE STRUCTURES FOR BUILDINGS" OR AS NOTED

#### STRUCTURAL STEEL:

1)ALL STRUCTURAL STEEL COLUMNS TO BE G40.21-M 350W GRADE

- 2)ALL STRUCTURAL STEEL BEAMS TO BE G40.21-M 300W GRADE
- 3)ALL BOLTS TO BE 3/4 ASTM A36 UNLESS NOTED OTHERWISE

4)GROUT UNDER COLLINN BASEPLATES TO BE A NON-SHRINKING, NON-METALLIC, PRE-BLENDED GROUTING COMPOUND CAPABLE OF A MINIMUM COMPRESSIVE STRENGTH OF 20 mPo AT 3 DAYS AND 50 mPo AT 28 DAYS

5)STEEL FABRICATOR SHALL BE CERTIFIED BY THE CWB AS PER W47.1 DIVISION #2

6)RICHARDS CONSULTING & ASSOCIATES LTD. REQUIRES TWO SETS OF SHOP DRAWINGS FOR REVIEW AND APPROVAL BEFORE ANY STRUCTURAL STEEL WORK CAN BEGIN 7)STRUCTURAL STEEL TO CONFORM TO CSA CAN-G40.21, "STRUCTURAL QUALITY STEELS" AND CSA G40.20 "GENERAL REQUIREMENTS FOR ROLLED OR WELDED STRUCTURAL QUALIFY STEEL

8)ALL STRUCTURAL STEEL PLATES TO BE G40.21-44W 9)FABRICATION AND ERECTION OF STRUCTURAL STEEL SHALL BE PERFORMED IN ACCORDANCE

WITH CAN3-S16.1-M84 'STEEL STRUCTURES FOR BUILDINGS 10) ALL WELDING SHALL CONFORM TO THE LATEST EDITION OF SCA W59 "WELDED STEEL

CONSTRUCTION 11) ALL STRUCTURAL STEEL IS TO RECEIVE ONE COAT OF SHOP PRIMER

12)NO HOLES PERMITTED IN TOP FLANGE OF BEAMS AT COLUMNS WHERE BEAMS ARE CONTINUOUS OVER COLUMNS

13) ALL BEAMS CONTINUOUS OVER COLUMINS ARE TO HAVE WEB STIFFENERS THE SAME SIZE AND ORIENTATION AS THE COLUMIN BELOW, UNLESS OTHERWISE NOTED 14) ANCHOR BOLTS TO BE PROVIDED BY STEEL SUPPLIER AND SET BY THE GENERAL

CONTRACTOR 15) FABRICATOR TO NOTIFY ENGINEER OF ANY PROPOSED MEMBER SUBSTITUTIONS AND

16) THE STRUCTURAL STEEL SUPPLIER SHALL PROVIDE AND BE RESPONSIBLE FOR ALL HOLES

16) THE STRUCTURAL STEEL SUPPLIER SHALL PROVIDE AND BE RESPONSIBLE FOR ALL HOLES IN STEEL SECTIONS REQUIRED BY OTHER TRADES. SECTION SHALL BE STRENCTH-DED WHERE REQUIRED TO GUARANTEE THE ORIGINAL STRENCTH OF THE BEAM. ANY CUITING OF STEEL AT THE 408 SITE SHALL BE DONE ONLY AS DIRECTED AND APPROVED BY THE ENGINEER 17) THE STRUCTURAL STEEL EXECTOR SHALL BE RESPONSIBLE FOR SUPPLYING AND ERECTING ALL TEMPORARY CUINING AND BRACING TO PROVIDE STABILITY FOR THE SRUCTURE AS A WHOLE. THESE SHALL REALNIN IN PLACE UNTIL ALL STEEL DECKING IS ERECTED, WELDED IN PLACE AND ALL MASONRY WALLS CONSTRUCTED

18) ALL DUCTS LARGER THAN 18" X 18 THROUGH ROOF DECK TO BE FRAMED WITH 3X3X1/4 ANGLES ALL AROUND, EXCEPT AS NOTED. SMALLER OPENINGS THROUGH STEEL DECK TO BE STIFFENED BY STEEL DECK SUPPLER. WHERE STEEL DECK REVERSES ITS FRAMING DIRECTION, USE 2 1/2xz / 2xn/2x ANGLE TO SUPPORT THE EDGE

#### WOOD DOORS AND FRAMES:

1)INTERIOR WOOD DOORS TO CONFORM TO CSA 0132.2 2)INTERIOR WOOD DOORS TO BE EITHER 1 3/4" (45 mm) SOLID OR 1 3/8" (35 mm)

HOLLOW CORE. (SEE DOOR SCHEDULE)

3)PAINT GRADE DOORS TO BE UNFINISHED HARDROARD

4)STAIN GRADE DOORS TO BE OAK VENEER UNLESS OTHERWISE NOTED.

5)WOOD FRAMES TO BE SOLID WOOD FOR JAMBS, STOPS, AND CASING, FINISH TO MATCH 6)WOOD DOORS IN WOOD FRAMES AS DETAILED ON DOOR AND HARDWARE SCHEDULE TO BE PREHUNG FLUSH DOOR UNITS.

#### METAL DOORS AND FRAMES

1) ALL EXTERIOR METAL DOORS ARE TO BE 18 go. INSULATED CORES

2)ALL INTERIOR METAL DOORS ARE TO BE 18 gd. HONEY COMB CORE

3)ALL METAL DOORS TO HAVE TACK WELD SEAMS @ 6" (150 mm) O.C. ALL SEAMS TO BE GROUND SMOOTH AND FILLED 4) ALL METAL DOOR FRAMES TO BE 16 gg. SINGLE PIECE, FULLY WELDED

#### EXTERIOR ALUMINUM DOORS AND FRAMES

1)PRE FINISHED ALUMINUM FLOORS TO BE KAWNEER NARROW STYLE #190 OR EQUIVALENT 2)MANUFACTURER'S HARDWARE

- OFFSET PNOT HINGES, STYLE 'C' PUSH/PULL AND ANY OTHER HARDWARE AS PER DOOR SCHEDULE. ANY MASTER KEYED CYUNDERS TO BE SUPPLIED BY HARDWARE SUPPLIER

3)PRE FINISHED ALUMINUM DOOR FRAMES TO BE KAWNEER 'TRI-FAB 450, 1 3/4' (45 mm)X4 1/2" (115mm). FRAMES WITH FLUSH GLAZING OR EQUIVALENT

#### DOOR HARDWARE:

1) ALUMINUM DOORS ARE TO HAVE HARDWARE SUPPLIED AND INSTALLED BY DOOR MANUFACTURERS

2)ENSURE ALL HARDWARE IS ADJUSTED AND WORKING PROPERLY 3) PROVIDE MANUFACTURER'S INSTRUCTION CLOSURES AND LOCK SETS. SHOW PROPER CARE,

LUBRICATION, AND ADJUSTMENTS FOR ALL HARDWARE 4)LOCK SETS TO BE GRAND MASTER KEYED DURING CONSTRUCTION WITH ALL KEYS RETURNED AND ACCOUNTED FOR

#### MILLWORK/CABINETRY:

1)MILLWORK FABRICATOR TO VISIT THE SITE TO VERIFY ALL DIMENSIONS PRIOR TO PRODUCING SHOP DRAWINGS AND BEGINNING CONSTRUCT

2)SHOP DRAWINGS ARE TO BE SUBMITTED TO RICHARDS CONSULTING & ASSOCIATES LTD. FOR REVIEW PRIOR TO FABRICATION 3)OWNER SHALL SUPPLY COLORS AND FINISHES FROM MANUFACTURER'S STANDARD SAMPLES

4) GENERAL CONTRACTOR IS TO SUPPLY BLOCKING AS REQUIRED FOR ALL WALL MOUNTED CABINETS 5)ALL EDGES TO BE CHAMFER OR RADIUS. NO SHARP EDGES

6)ALL DOORS COMPLETE WITH FULLY CONCEALED 170 DEGREE STEEL HINGES

7)UNLESS OTHERWISE SPECIFIED, ALL PULLS ARE TO BE 26D FINISHED BRUSHED CHROME 8) ALL DRAWERS TO HAVE HEAVY METAL ROLLER DRAWER GUIDES 9)DOOR AND DRAWER LOCKS TO BE CONFIRMED WITH OWNER

10) FINISH TO BE CONFIRMED WITH OWNER

#### RUBBER BASE:

1)1/8"X4" (JmmX100mm) COLORED COVE BASE COMPLETE WITH MATCHING PREFORMED INSIDE AND OUTSIDE CORNERS, COLOR BY OWNER.

WASHROOMS: 1) SOAP DISPENSER:

2)PAPER TOWEL DISPENSER:

3)PAPER TOWEL WASTE RECEPTACIE:

AND COLOR BY OWNER

TOILET TISSUE DISPENSER:

5)MIRRORS:

MIRRORS

2)GRAB BARS:

3)MIRRORS:

4)COUNTERS:

5)SINKS:

OPERABLE

BARRIER -FREE WASHROOMS:

1) REFER TO WASHROOM GENERAL NOTES

TO 1 3/4" (45 mm) FROM WALL

WALL IS MIN. 18' (460 mm)

STYLE BY OWNER

- ONE DISPENSER IS REQUIRED BETWEEN EVERY TWO LAVATORY SINKS

- INSTALL DISPENSER BETWEEN 900mm-1000mm FROM FLOOP

MIN. OF 1 WASTE RECEPTACLE IS REQUIRED PER WASHROOM

- ONE DISPENSER IS REQUIRED PER STALL OR TOILET COMPAR - INSTALL DISPENSER BETWEEN 750mm-850mm FROM FLOOR

- MIRROR TO BE 1/4" (6mm) CLEAR FLOAT - 24"X36" (610mmX915mm)

DISPENSER TO BE SURFACE MOUNTED, COLOR AND STYLE BY OWNER

DISPENSER FOR LIQUID SOAP TO HAVE A CAPACITY OF 40 oz. (1200 MI)

- DISPENSER TO BE SURFACE MOUNTED ROLL OR SINGLE SHEET DISPENSER, COLOR AND

ONE DISPERSER IS REQUIRED PER WASHROOM IF ONLY UP TO 3 SINKS AND A MIN. OF 2 REQUIRED FOR MORE THAN 3 SINKS INSTALL DISPENSER BETWEEN 1100mm-1300mm FROM FLOOR

WASTE RECEPTACLE TO BE FREE STANDING, MOUNTED, OR BUILT IN WITH A MIN. CAPACITY

OF 17 GAL (80 L) COMPLETE WITH REMOVABLE LINER AND PUSH THROUGH UD, STYLE

- DISPENSER TO BE WALL MOUNTED, MULTIPLE ROLL TYPE, COLOR AND STYLE BY OWNER

6) GENERAL CONTRACTOR IS TO SUPPLY BLOCKING AS REQUIRED FOR ALL WALL MOUNTED

- GRAB BAR IS REQUIRED IN EVERY BARRIER-FREE STALL OR TOILET COMPARTMENT - GRAB BAR TO BE MOUNTED HORIZONTALLY ON WALL BESIDE TOILET, LOCATED WITH ITS CENTERLIVE 12 (300 mm) ABOVE THE HEIGHT OF THE TOILET SEAT AND WITH ITS MIDPOINT LOCATED IN LINE WITH THE FRONT EDGE OF THE TOILET SEAT AND WITH ITS

- GRAB BAR TO BE 1 1/2 (40 mm) IN DIAMETER, POLISHED CHROME FINISH WITH KNURLED GRIP AND EXPOSED FASTENERS

7)ALL OTHER DISPENSERS TO BE INSTALLED BETWEEN 1100mm-1300mm FROM FLOOR

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HARDS

27317 TWP RD 372 RED DEER COUNTY

ALBERTA T4N 5E3

30'-0" X 42'-0" DETACHED GARAGE

RED DEER COUNTY, ALBERTA

22 HUMMINGBIRD HALF MOON BAY

GENERAL NOTES

JOB NUMBER PAGE NUMBER REVISION

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08DFC2023

08DEC2023

08DEC2023

LEGAL DESCRIPTION

DRAWING TITLE

SCALE DESIGNED BY M. RICHARDS

DRAWN ED

22440

L. LUNDGREN CHECKED B M. RICHARDS

403-886-2919 F: 403-886-2733

GARAGE

-FAUCET HANDLES TO BE LEVER TYPE WITHOUT SPRING LOADING OR BE AUTOMATIC

-SOAP AND TOWEL DISPENSERS TO BE LOCATED MAX. 48 (1200 mm) ABOVE FLOOR IN THE AREA ACCESSIBLE BY WHEELCHAIR

EXPOSED PARTS TO BE INSULATED WHERE THEY WOULD OTHERWISE PRESENT A BURN HAZARD

CELEARANCE BENEATH SINK TO BE MIN. 30° (760 mm) WIDE X 29° (735 mm) HIGH @ FRONT EDGE, 27° (685 mm) HIGH @ 8° (205 mm) BACK FORM FRONT EDGE, 9° (230 mm) HIGH OVER THE DISTANCE FROM 11° (280 mm) TO 17° (430 mm) BACK FROM

-RIM HEIGHT TO BE MAX. 34 (865 mm) ABOVE FLOOR

-SINKS TO BE LOCATED SO THAT THE DISTANCE BETWEEN ITS CENTERLINE AND THE SIDE


-FRONT EDGE CLEARANCE TO BE MINIMUM 29" (735 mm)

-COUNTER SURFACE TO BE MAX. 34" (865 mm) ABOVE THE FLOOR


-MAX. DISTANCE FROM FLOOR TO UNDERSIDE OF MIRROR TO BE 39' (1000 mm) IF THIS IS NOT ACHIEVABLE, USE TILTED MIRRORS


- GENERAL CONTRACTOR IS TO SUPPLY BLOCKING AS REQUIRED FOR ALL GRAB BARS.


GRAB BAR TO BE 48 (1200 mm) LONG AND HAVE A CLEARANCE OF 1 3/8" (35 mm)

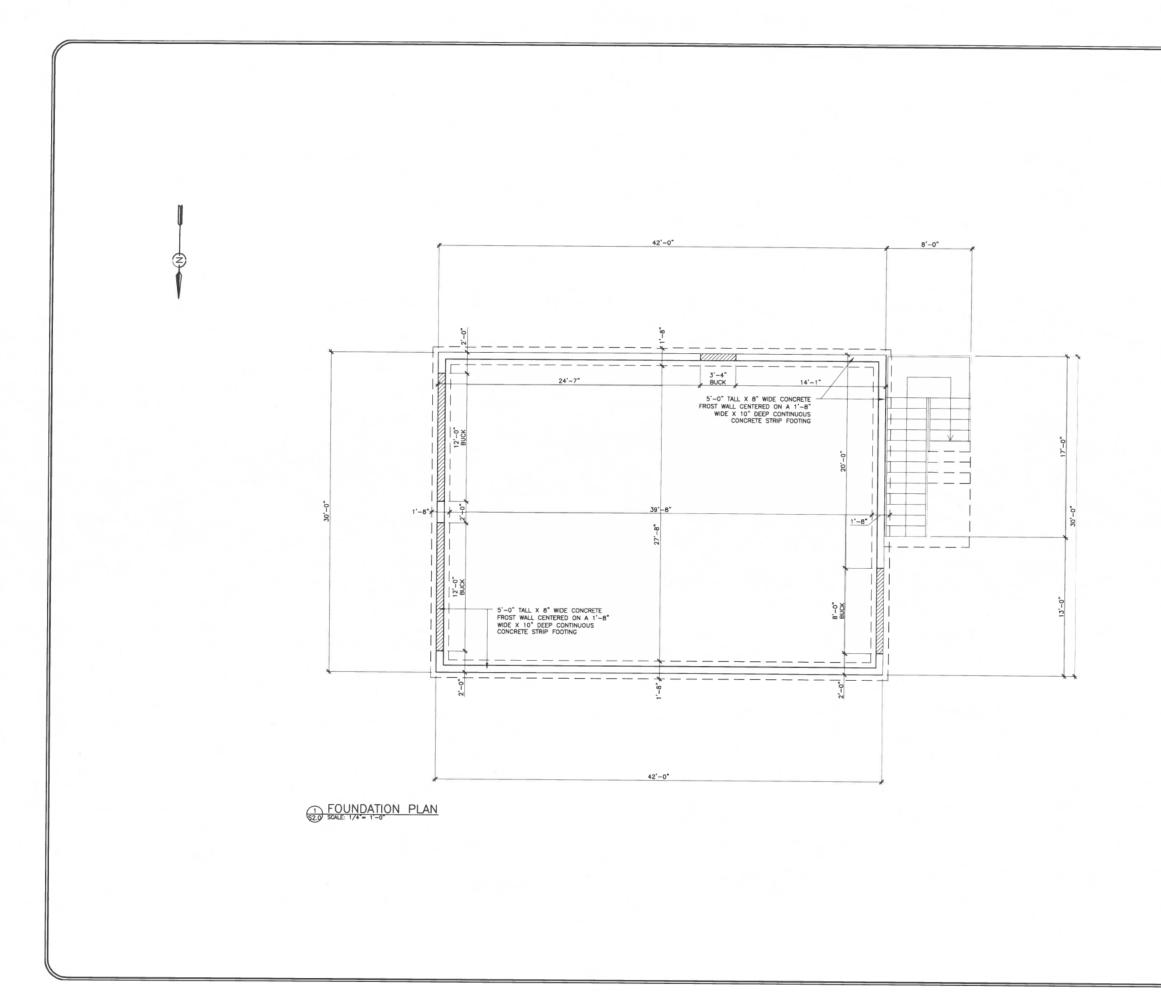


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	40 <sup>8</sup>	
	STAMPS	
	1 ISSUED FOR REVIEW NO. REVISION → RICHA	080EC23(LL DATE BY RDS ULTING & CIATES D
	27317 TWP RED DEER ALBERTA T P: 403-886-2919 F CUSTOMER	RD 372 COUNTY, 4N 5E3
	PROJECT 30'-0" X DETACHED RED DEER COUN	42'-0" GARAGE
	LEGAL DESCRIPTION 22 HUMMIN HALF MOOT DRAWING TITLE FOUNDATIO SCALE	IGBIRD N BAY
	DESIGNED BY M. RICHARDS DRAWN BY L. LUNDGREN CHECKED BY M. RICHARDS JOB NUMBER PAGE NU	DATE 08DEC2023 DATE 08DEC2023 DATE 08DEC2023 MBER REVISION
Pag	ge 14	

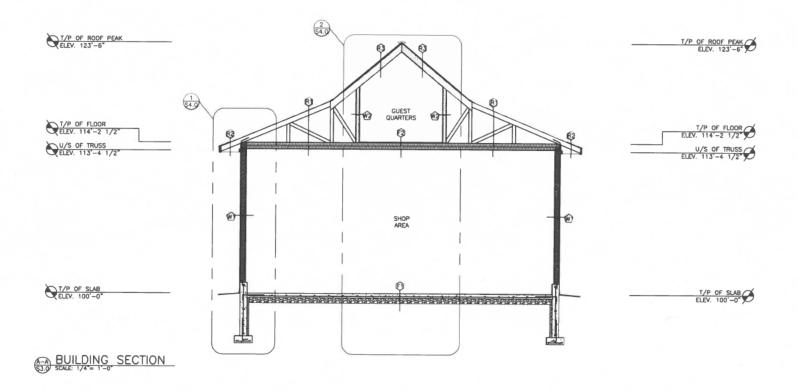


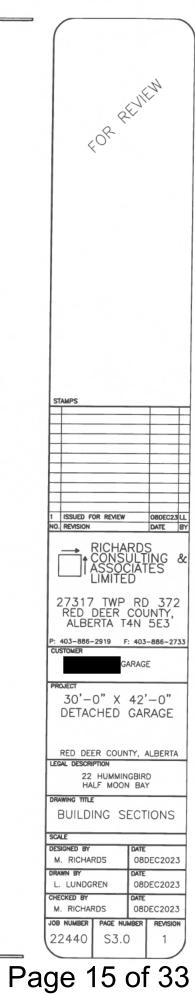

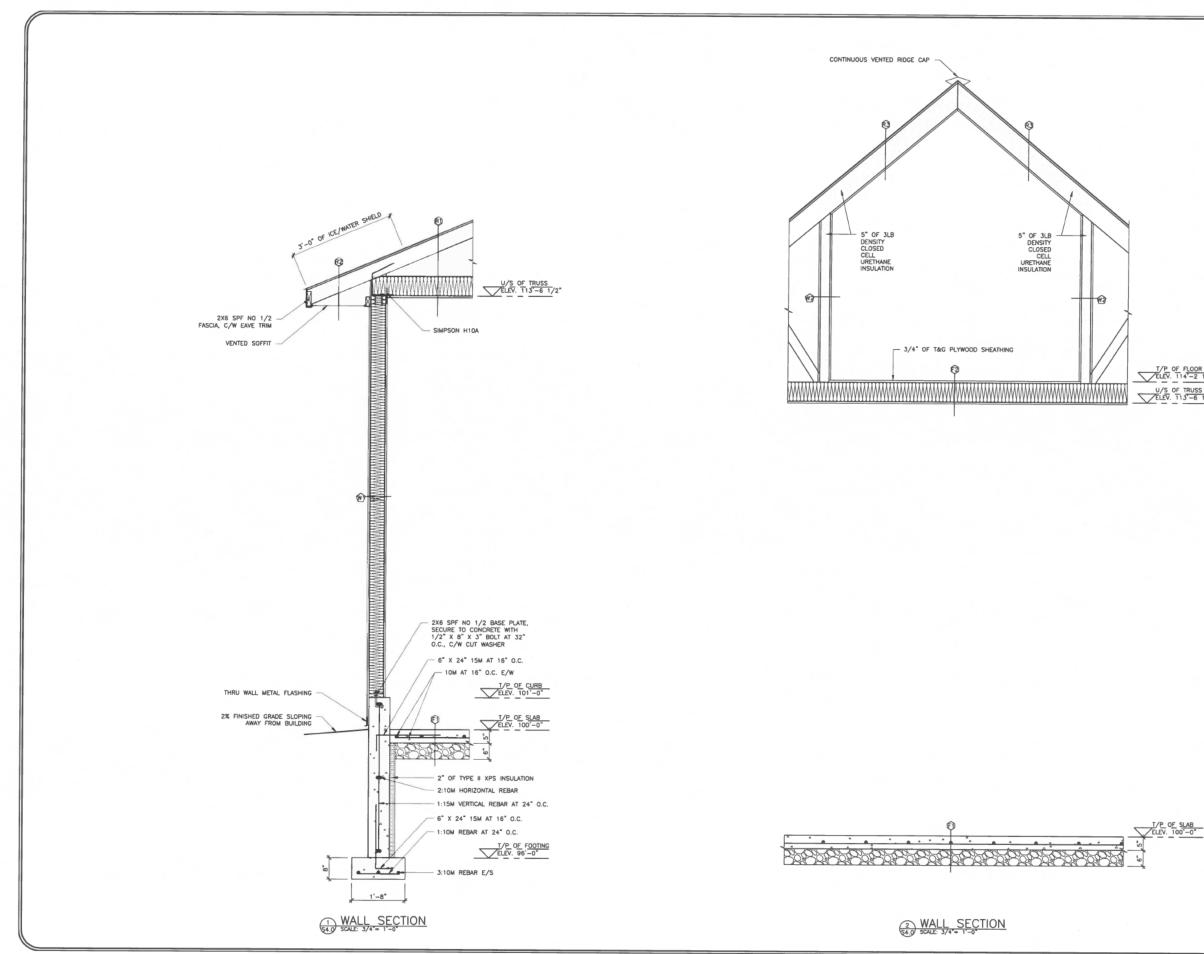


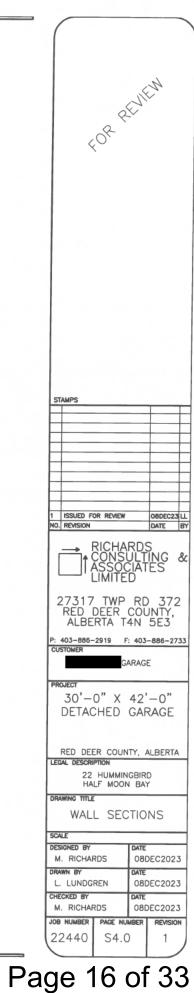


T/P OF FLOOR ELEV. 114'-2 1/2" U/S OF TRUSS ELEV. 113-6 1/2\*

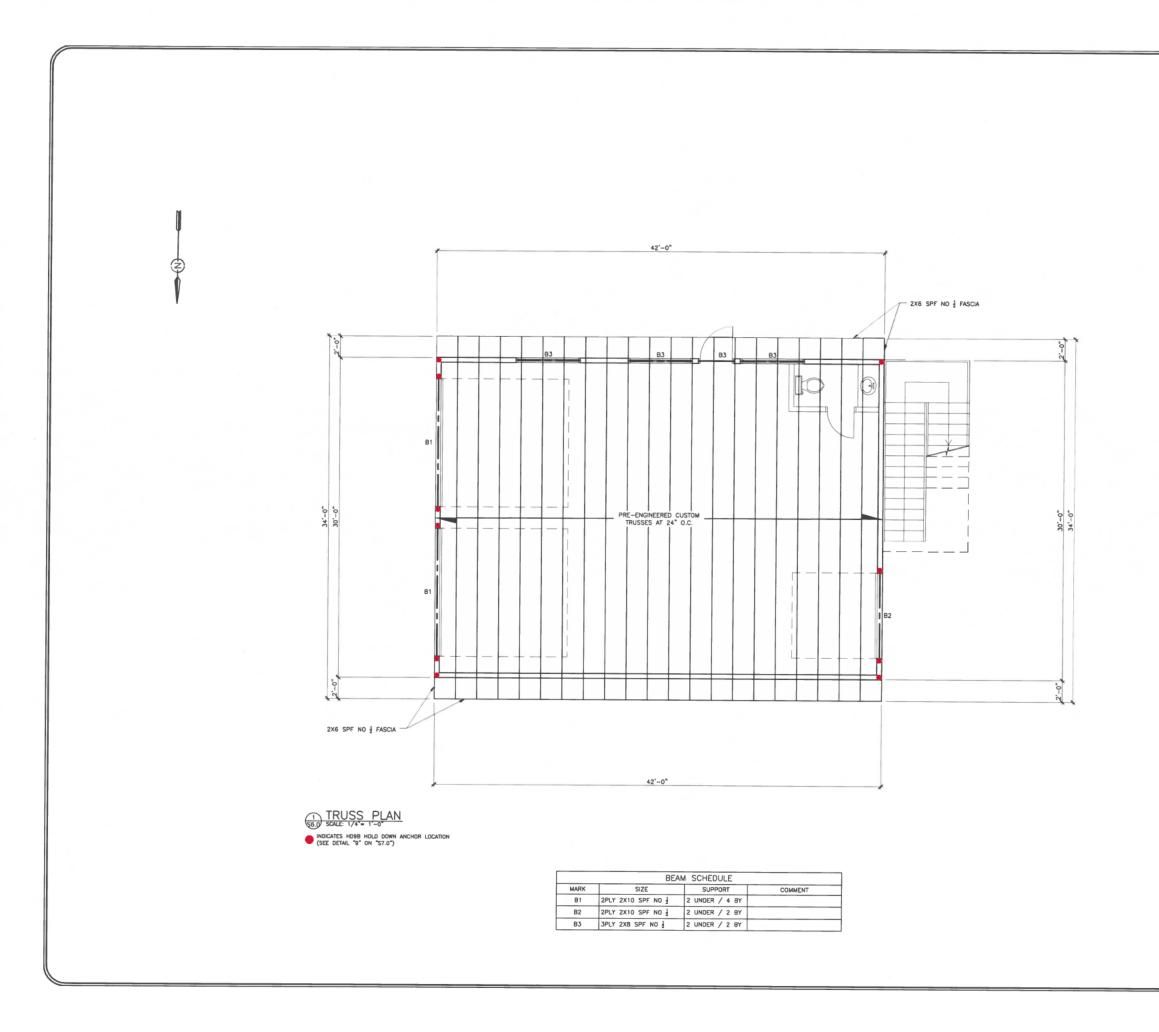




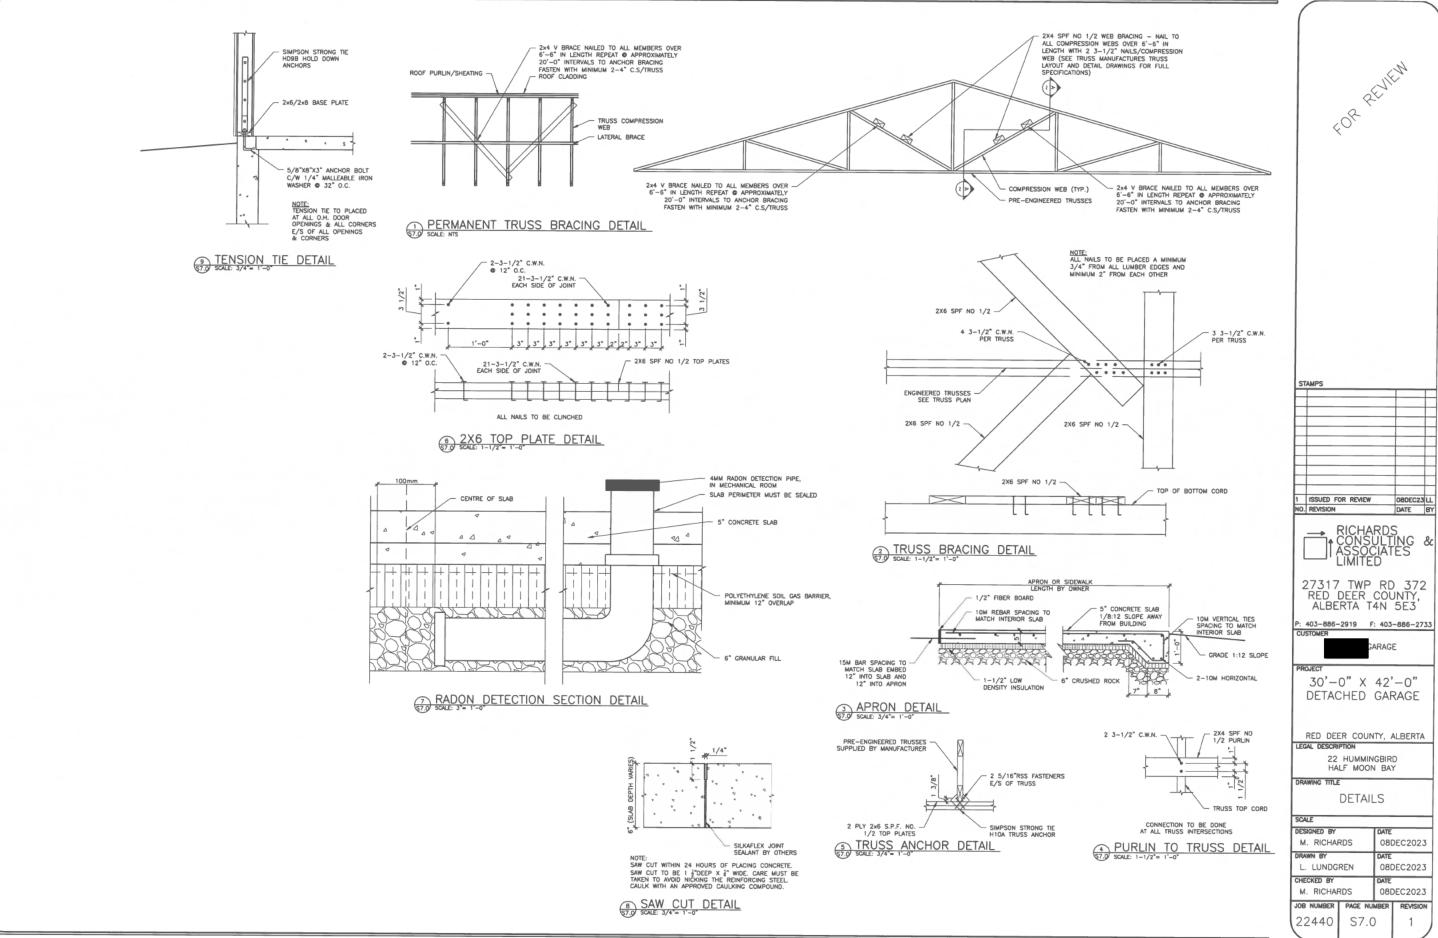




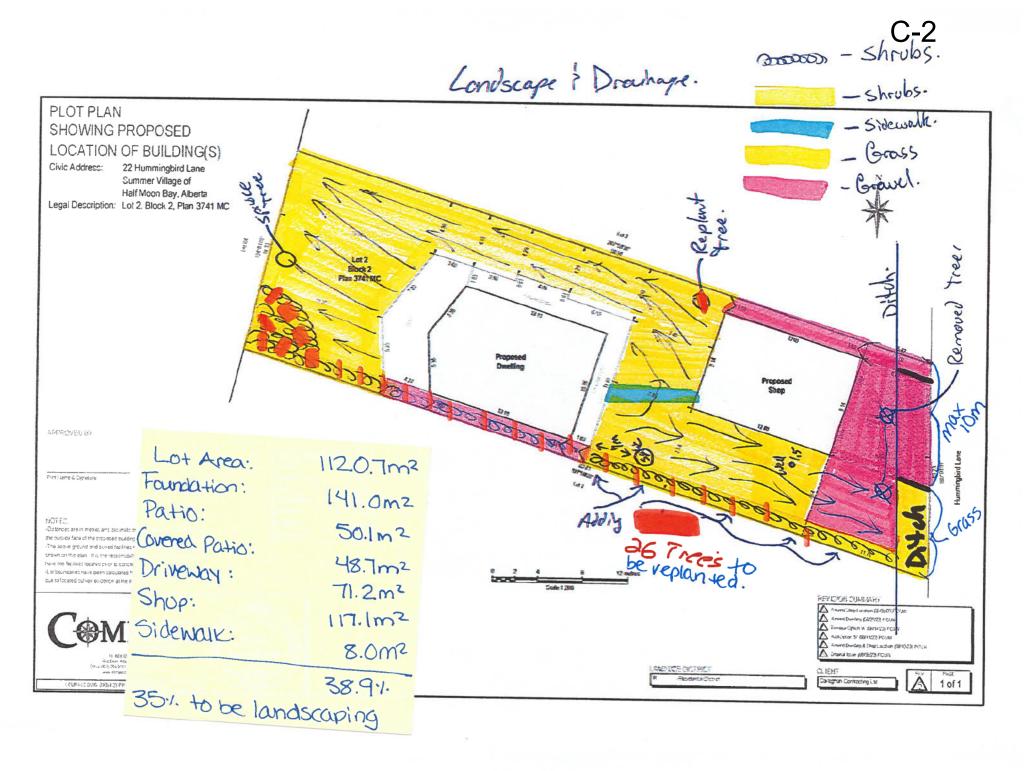

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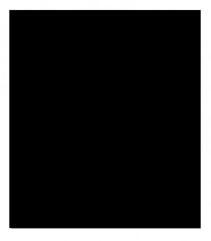


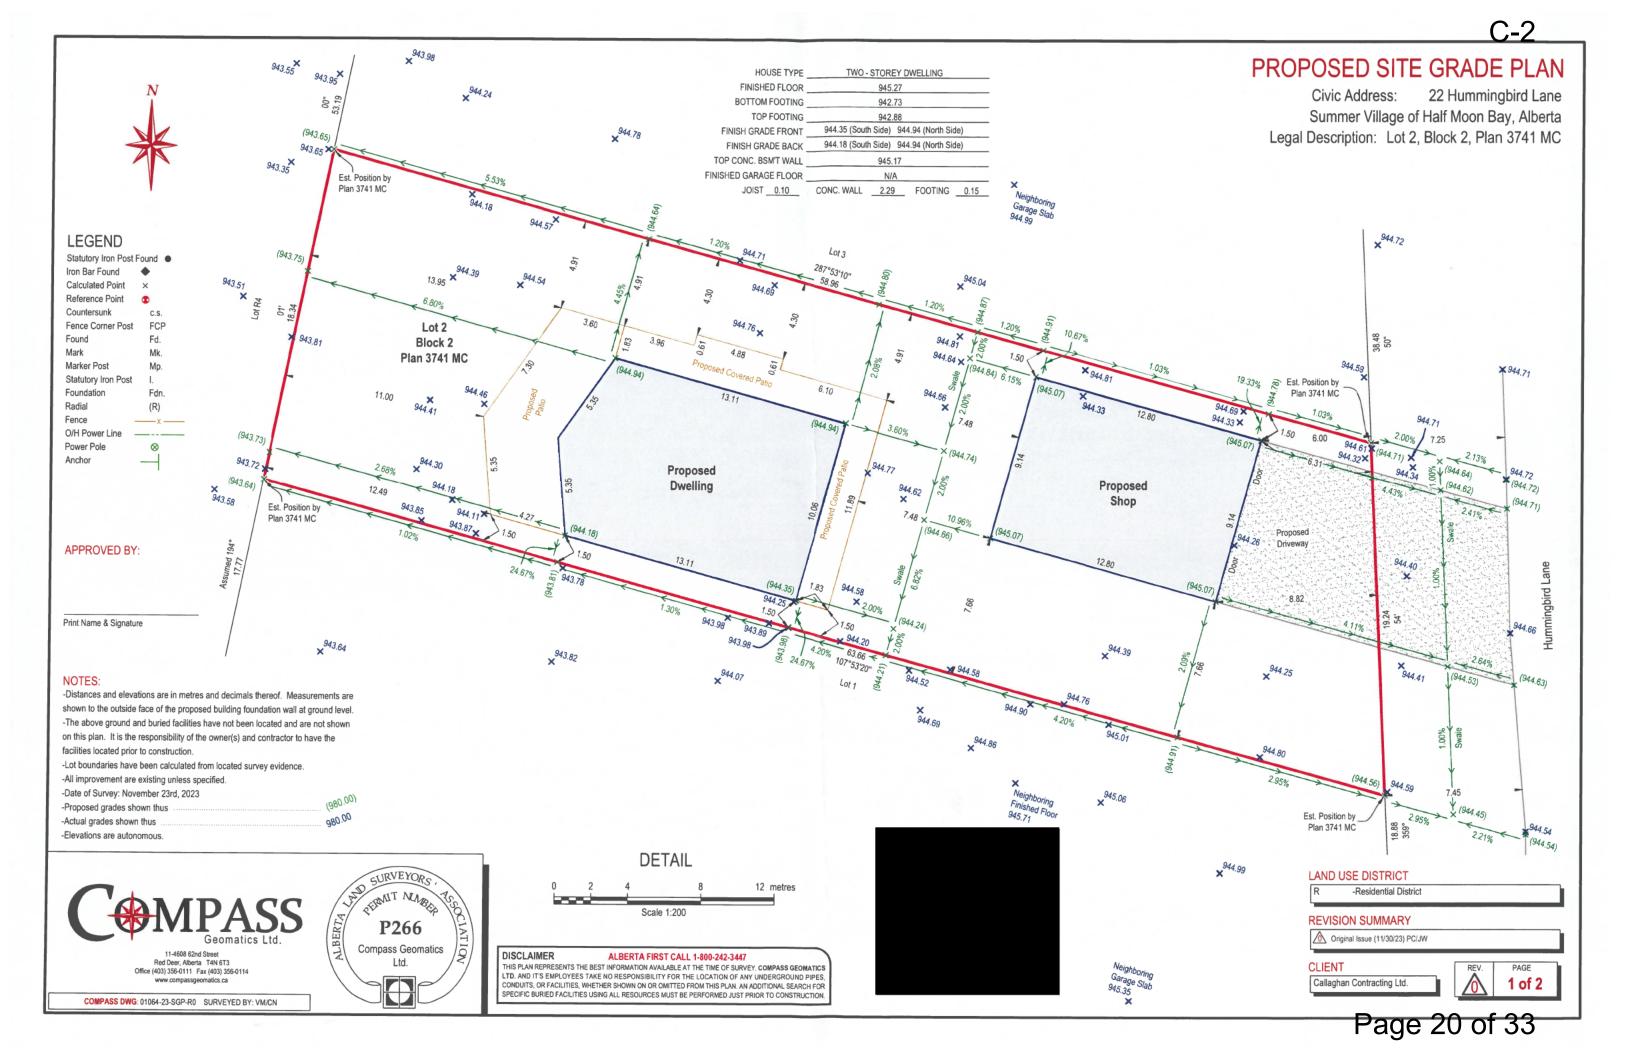
### PROPOSED SITE GRADE PLAN

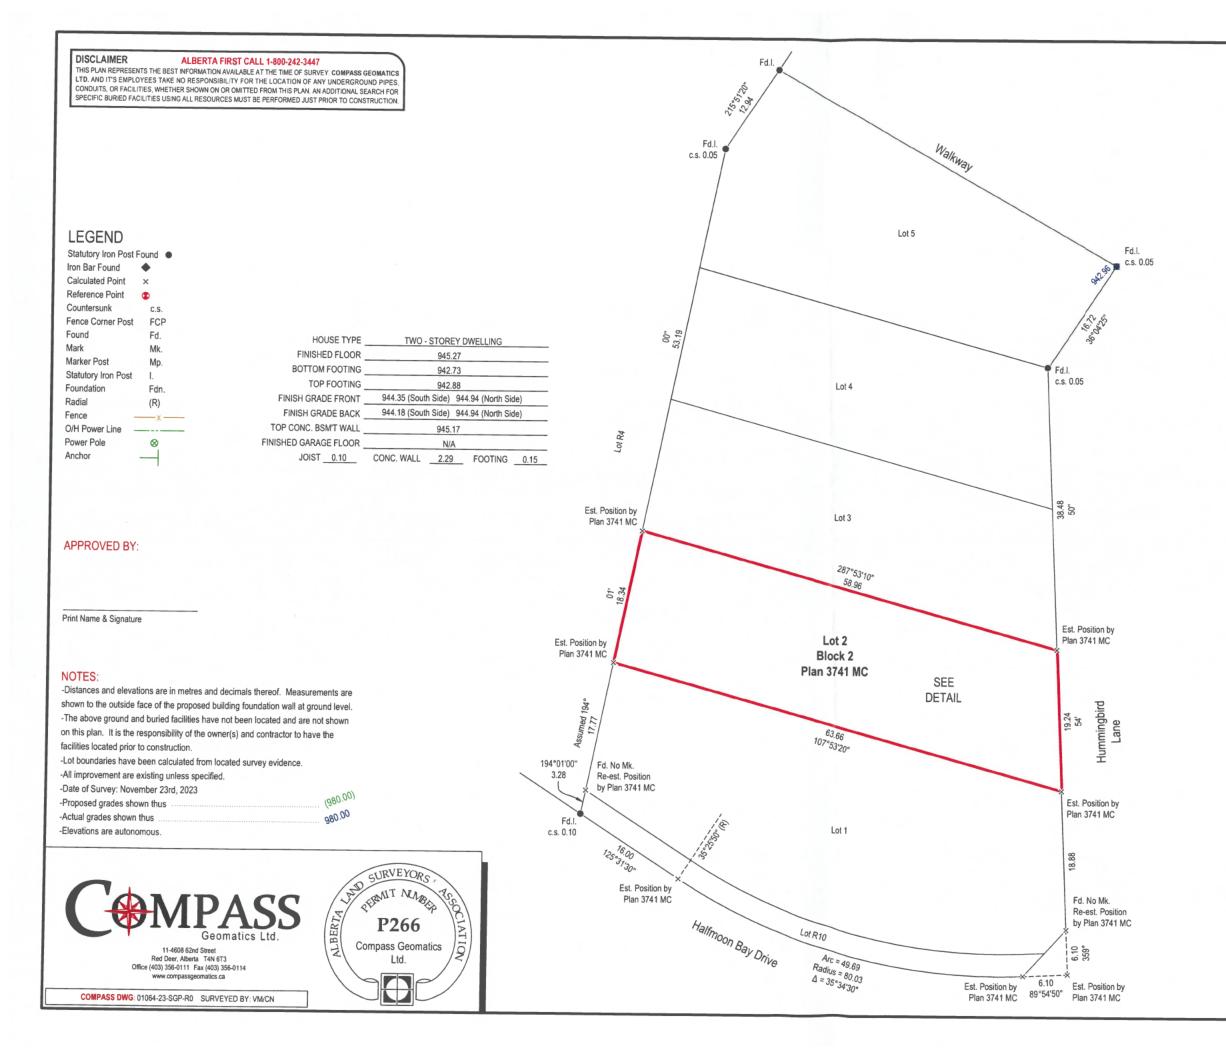**C-2** 

Civic Address: 22 Hummingbird Lane Summer Village of Half Moon Bay, Alberta Legal Description: Lot 2, Block 2, Plan 3741 MC






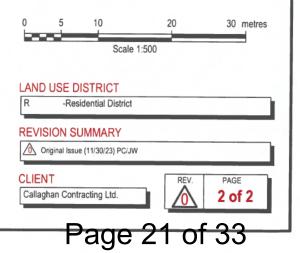







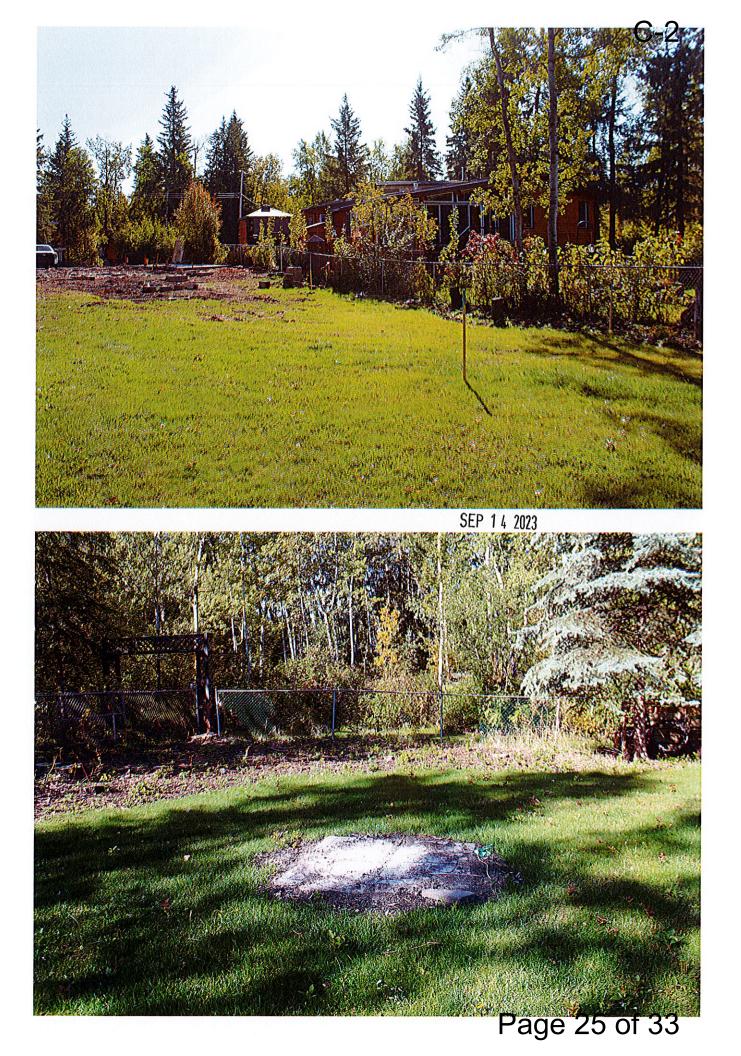











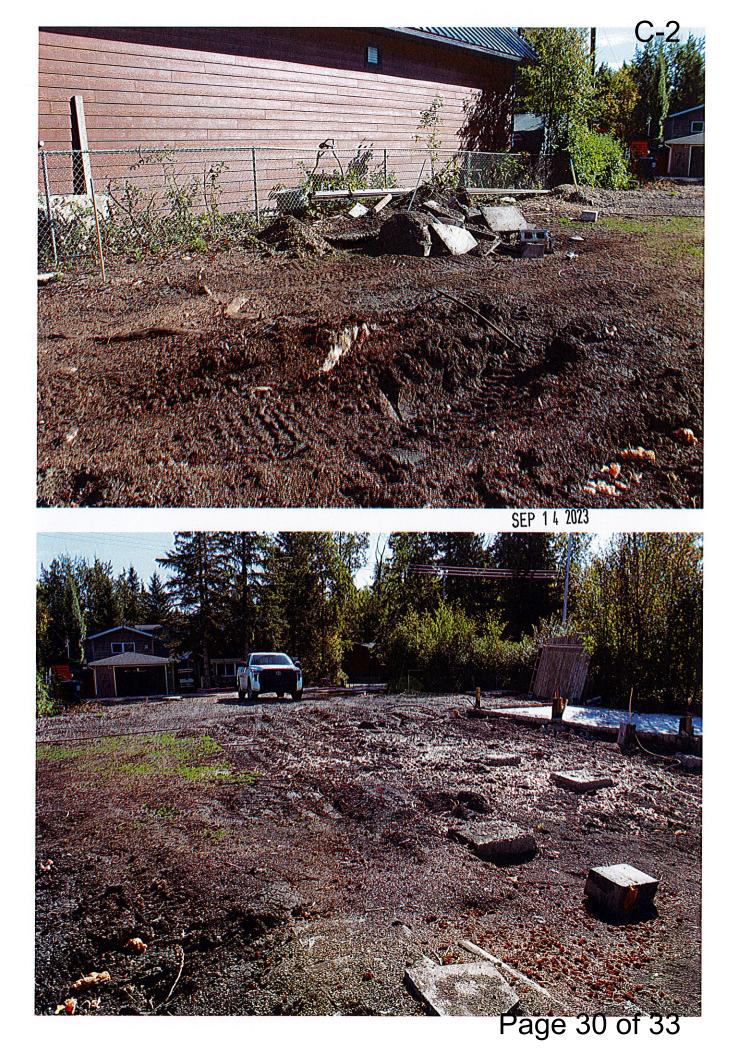





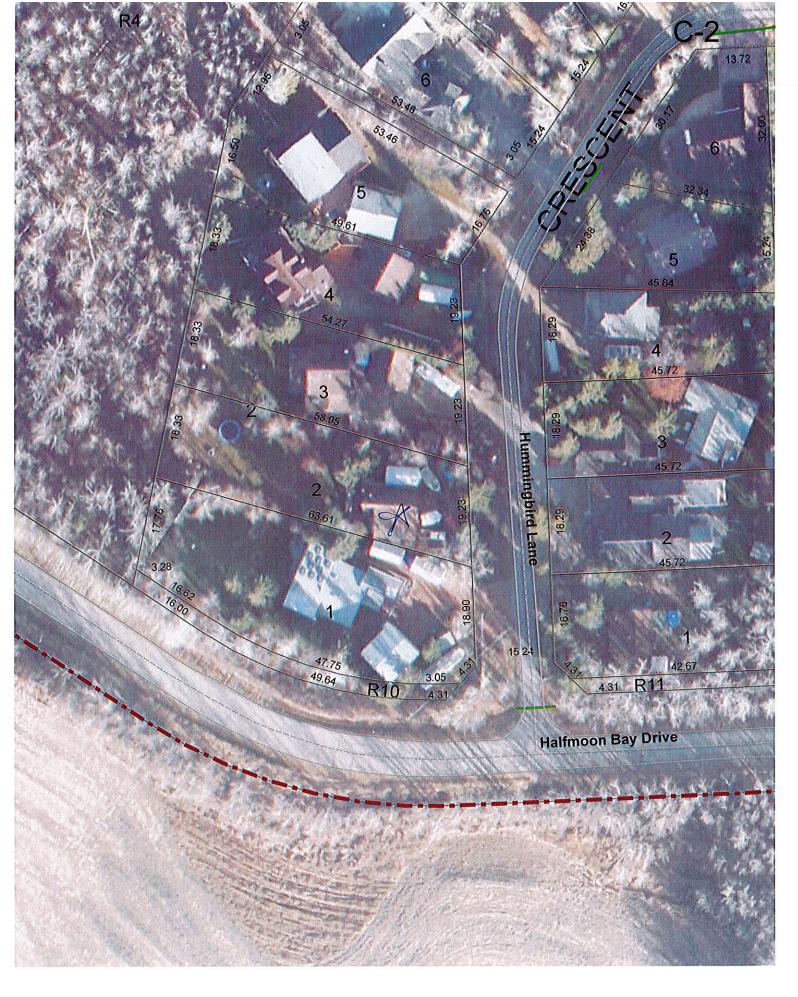

Lot 2

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