### MUNICIPAL PLANNING COMMISSION AGENDA SUMMER VILLAGE OF BIRCHCLIFF SUMMER VILLAGES ADMINISTRATION OFFICE JANUARY 24, 2021 @ 9:00 A.M.

- A. CALL TO ORDER
- B. ADOPTION OF AGENDA
- C. DEVELOPMENT ITEMS
  - 1) 163 Birchcliff Road
- D. ADJOURNMENT

### **Summer Village of Birchcliff – Municipal Planning Commission**

Agenda Item

**January 24, 2022** 

163 Birchcliff Road (Lot 16, Block 3, Plan 4112EO)

#### **Development Permit Application**

#### **Background:**

An application was submitted on behalf of the homeowners of 163 Birchcliff Road (Lot 16, Block 3, Plan 4112EO) in the Summer Village of Birchcliff for a garage with guest house. This property is in the R1 District (Lakeshore Residential).

The proposed garage with guest house meets the yard setbacks and height requirement. The proposed lot coverage is 49.6% and under the maximum 50% with the accessory building being 1,068 ft<sup>2</sup>. The proposed garage with guest house meets the requirements to have a side entry garage and 10 trees and shrubs being removed will be replaced with 8 trees and 12 shrubs according to the landscaping plan.

#### **Discussion:**

This application is before MPC for the following reasons:

- Guest House is listed a discretionary use, therefore the decision must come from the Municipal Planning Commission.
- Accessory building's combined footprints shall be no larger than 6% of the parcel's total area, to a maximum of 2,200 ft<sup>2</sup>, the accessory building's footprint totals 1,068 ft<sup>2</sup>, which is a footprint of 13.2% on a lot size of 8,084.72 ft<sup>2</sup>, therefore a variance is required.
- Guest house means an accessory building containing sleeping facilities for temporary usage only and may have a bathroom but shall not have a kitchen or other cooking facilities, therefore a variance is required.

#### **Recommendation:**

After reviewing the application and all relevant planning documents, it is the recommendation of administration to deny the application for the garage with guest house. The accessory building's footprint requires a large variance, and the guest house contains a kitchen. "Accessory building(s) means a building separate and subordinate to the main building", the proposed garage with guest house is not considered subordinate in size and height to the dwelling as the accessory building is larger in size and height. Adjacent landowners have been notified and no response has been received.

#### **Conditions:**

If approved, Administration would recommend the following conditions:

- An accessory building erected or placed on a parcel shall not be used as a dwelling unit.
- Electrical power from the property line to any buildings situated on this parcel to be constructed underground.
- The exterior of an accessory building must be finished to match or compliment the exterior finish of the main building.
- In situations where a detached dwelling is being rented out and there is a guest house on the parcel, the guest house shall not be rented out to a separate party than those renting the detached dwelling.
- The accessory building shall not exceed 7.62m (25ft.) in building height.
- Footing check survey required from an Alberta Land Surveyor at the time of footings prior to continuation of construction.
- Completions Deposit of \$3,000.00.
- Trees removed to be replaced according to landscaping plan.

#### **Authorities:**

For a discretionary use in any district:

- The Municipal Planning Commission may approve an application for a Development Permit:
  - With or without conditions;
  - Based on the merits of the proposed development, including it's relationship to any approved statutory plan, non-statutory plan, or approved policy, affecting the site;
  - Where the proposed development conforms in every respect to this Land Use Bylaw; or
- May refuse an application for a development permit based on the merits of the proposed development, even though it meets the requirements of the Land Use Bylaw; or
- Subject to provisions of section 2.4 (2), the Municipal Planning Commission shall refuse an application for a development permit if the proposed development does not conform in every respect to the Land Use Bylaw.

#### The MPC may:

- Grant a variance to reduce the requirements of any use of the LUB and that use will be deemed to comply with LUB.
- Approve application even though the proposed development does not comply or is a non-conforming building if:
  - o It would not unduly interfere with the amenities of the neighborhood, or
  - Materially interfere with or affect the use, enjoyment, or value of neighboring parcels of land, And

- o It conforms with the use prescribed for that land or building in the bylaw.
- Consider a Variance only where warranted by the merits or the proposed development and in response to irregular lot lines, parcel shapes or site characteristics which create difficulties in siting structures within the required setback or in meeting the usual bylaw requirements, except there shall be no variance for Parcel Coverage or Building Height.

#### **Decision:**

In order to retain transparency of the Commission, Administration recommends one of the following:

- 1. Approve the application with or without conditions (Section 642 of the MGA), or
- 2. Deny the application stating reasons why (Section 642(4) of the MGA).

Geoffrey Stan GWS Contracting Ltd

January 4, 2022

Kara Kashuba Development Officer Summer Village of Birchcliff

To Whom it May Concern

This letter is written regarding #163 Birchcliff Road garage with living quarters.

We have submitted building plans, plot plan, landscaping plan and development application. This is a letter of intent with the following variance request as per your request:

a) Garage size

Sincerely

Geoff Stan GWS Contracting Ltd

# 163 BIRCHCLIFF RD

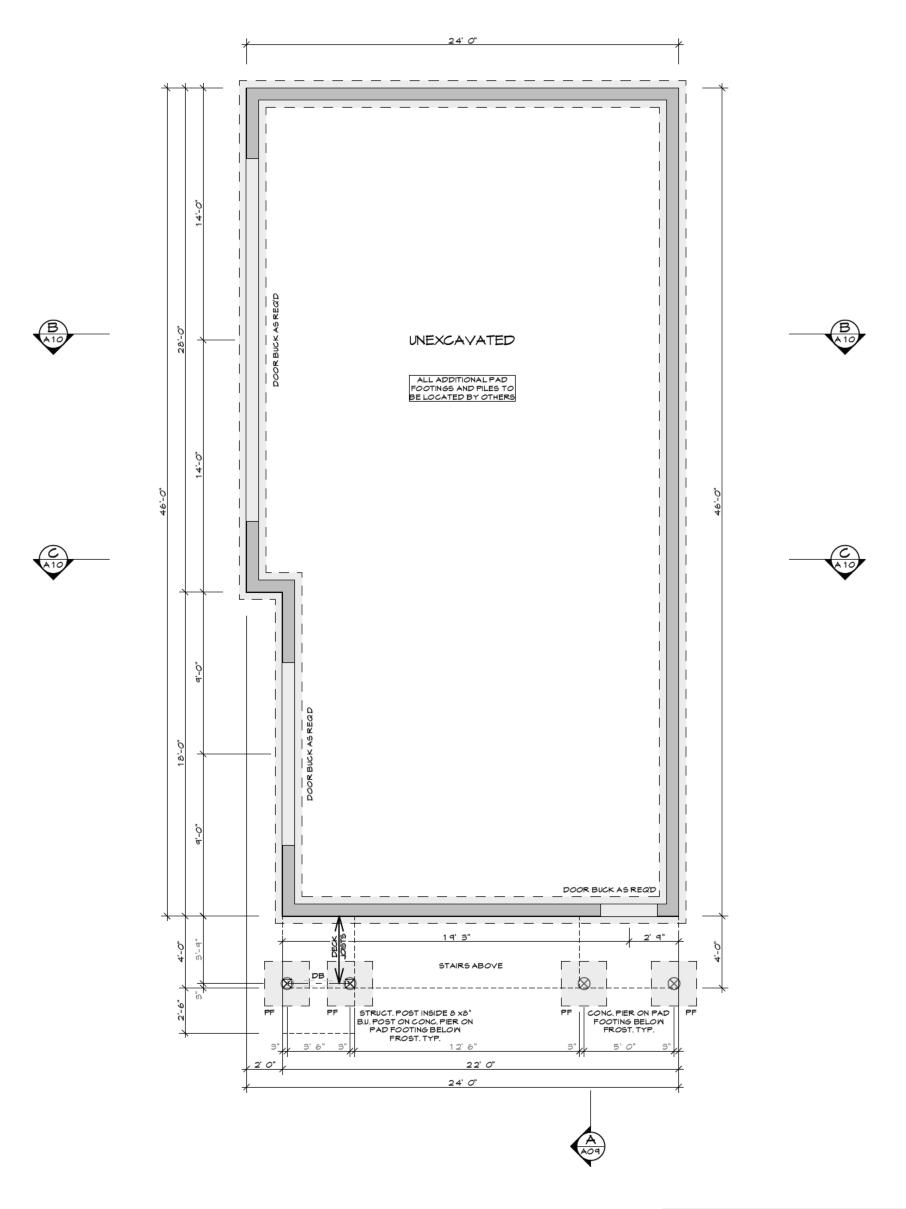


### LIST OF DRAWINGS

- AO1 TITLE PAGE
- A02 FOUNDATION PLAN
- A03 MAIN FLOOR PLAN
- A04 UPPER FLOOR PLAN
- A05 ROOFPLAN
- A06 ELEVATIONS
- AOT ELEVATIONS
- A08 ELEVATIONS
- A09 BUILDING SECTIONS
- A 10 BUILDING SECTIONS
- A11 CNST DTLS / NOTES / LEGENDS
- A12 SITE PLAN
- A 13 LANDSCAPE PLAN
- EO 1 MAIN FLOOR ELECTRICAL
- EO2 UPPER FLOOR ELECTRICAL





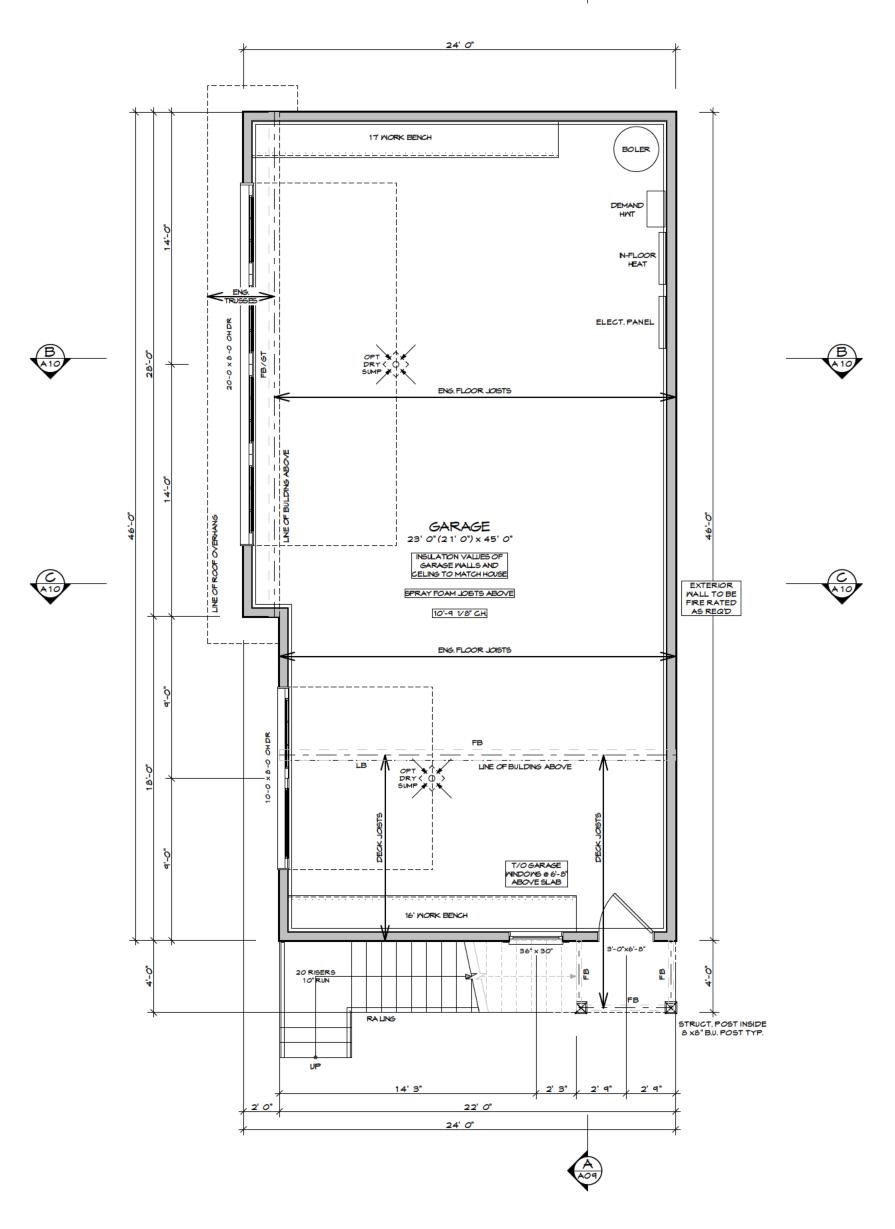


### FOUNDATION PLAN

ROUGH-IN FOR RADON EXTRACTION SYSTEM/ SUBFLOOR DEPRESSURIZATION SYSTEM TO BE INSTALLED AS PER BUILDING CODE REQUIREMENTS







# MAIN FLOOR PLAN

ALL DOWNSPOUT LOCATIONS TO BE CONFIRMED WITH BUILDER PRIOR TO INSTALLATION

ALL ROUGH OPENINGS TO BE SUPPLIED BY OTHERS ALL WINDOWS TO HAVE A MAX U-VAULE OF 1.6 OR MIN ENERGY RATING OF 25

ALL SPECFICATIONS FOR THE NBC 2019 (AE).
9.36. ENERGY CODE TO BE SUPPLIED BY
OTHERS,
DRAWINGS TO BE REVENED 4 APPROVED BY
THE LOCAL MINICIPALITY OR PERMITTING
AUTHORITIES.

LEGAL ADDRESS: LOT: 16, BLOCK: 2, PLAN: 4 1 12 EO /C ADDRESS: 163 BIRCHCLOFF RD, SV OF BIRCHCLIFF, AB CLIMATE ZONE: BUL

BULDING AREA: 99 SQ M

SCALE:

SHEET:

ARTIGHTNESS 2.5

MAN FLOOR: 0000 SF UPPER FLOOR SUITE: 192 SF TOTAL: 0000 SF

GARAGE: 1068 SF

DEV LOWER FLOOR: 0000 SF TOTAL LOWER FLOOR: 0000 SF TOTAL DEVELOPED: 0000 SF CA A

CLENT CONTACT INFO:

KD RESIDENTIAL

DRAFTED BY:

KAREN RICHINSKI
ARCHITECTURAL TECHNOLOGIST

CELL: 403.396.0354
EMAIL: KAREN®KDRD.CA
WEB: WWW.KDRD.CA

163 BIRCHCLEF RD GMS
SHEET TITLE:
MAIN FLOOR

PLAN

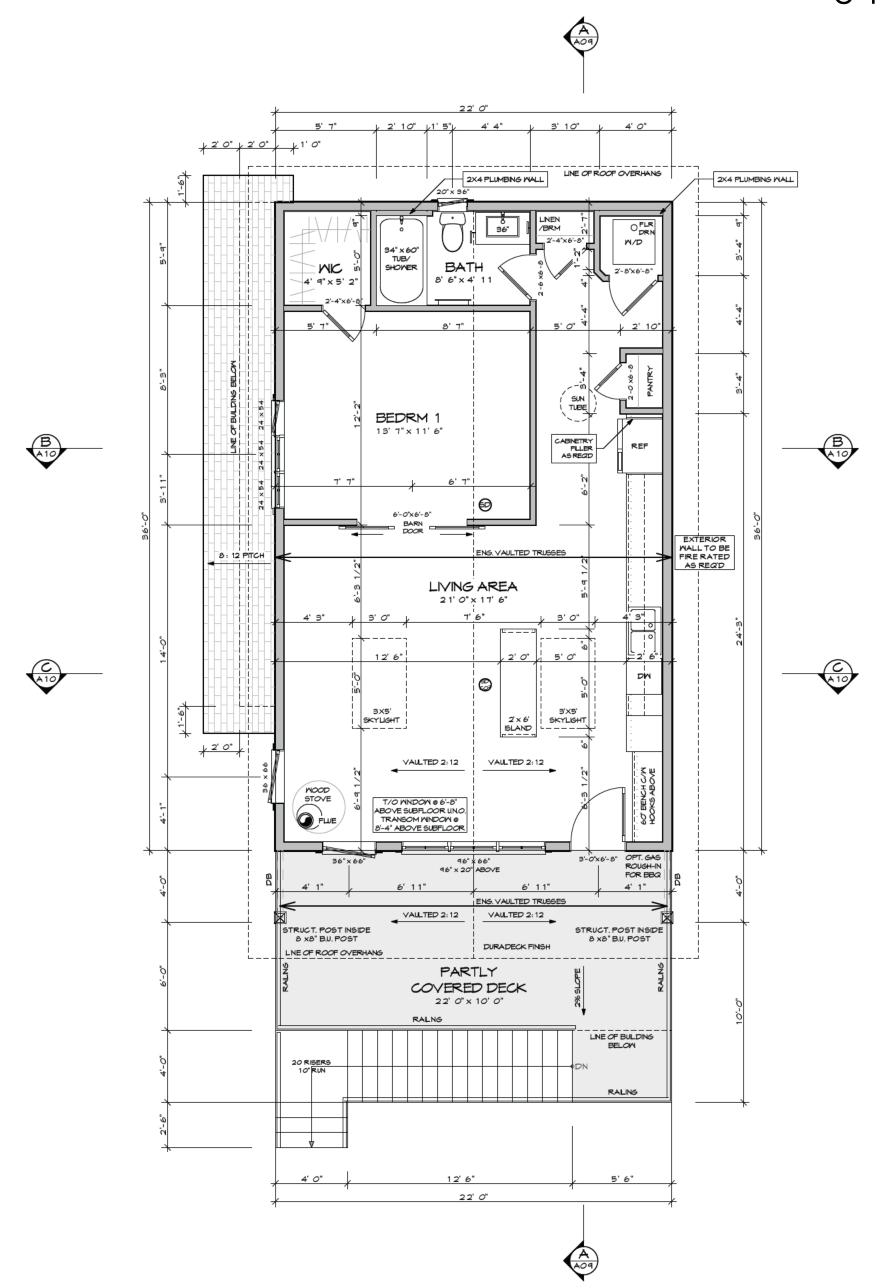
PROJECT NUMBER: GMS-2021-01

17-12-2021

3/16" = 1'-0"

A03

PROJECT NAME:



# UPPER FLOOR PLAN

ALL DOWNSPOUT LOCATIONS
TO BE CONFIRMED WITH BUILDER
PRIOR TO INSTALLATION

ALL ROUGH OPENINGS TO BE SUPPLIED BY OTHERS ALL WINDOWS TO HAVE A MAX U-VAULE OF 1.6 OR MIN. ENERGY RATING OF 25

ALL SPECFICATIONS FOR THE NBC 2019 (AE).
9.36. ENERGY CODE TO BE SUPPLIED BY
OTHERS.

DRAWINGS TO BE REVEWED & APPROVED BY
THE LOCAL MUNICIPALITY OR PERMITTING
AUTHORITIES.

LEGAL ADDRESS: LOT: 16, BLOCK: 2, PLAN: 4 1 12 EO

163 BRCHCLOFF RD, SV OF BIRCHCLIFF, AB CLIMATE ZONE: BUILDING
7A 99 SX

BULDING AREA: ARTIGHTNESS

99 SQ M 2.5

SHEET:

MAN FLOOR: 0000 SF UPPER FLOOR SUITE: 792 SF TOTAL: 0000 SF

DEV LOWER FLOOR: 0000 SF TOTAL LOWER FLOOR: 0000 SF TOTAL DEVELOPED: 0000 SF GARAGE: 1068 SF ON.

CLENT CONTACT INFO:

KD RESIDENTIAL

DRAFTED BY:

KAREN RICHINSKI ARCHITECTURAL TECHNOLOGIST CELL: 403.396.0354 EMAIL: KAREN@KDRD.CA WEB: WWW.KDRD.CA SHEET TITLE:

UPPER FLOOR
PLAN

77

163 BIRCHCLIFF

PROJECT NUMBER:

GMS-2021-01

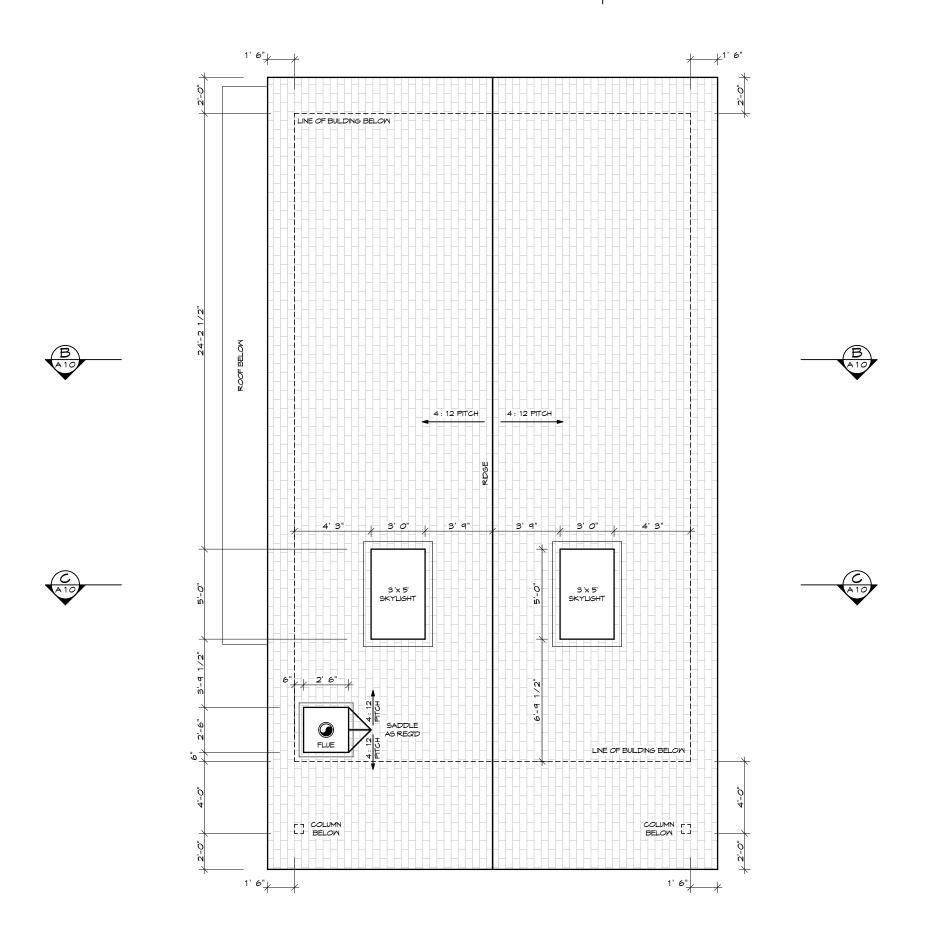
17-12-2021

SCALE: 3/16" = 1'-0"

A04

PROJECT NAME:



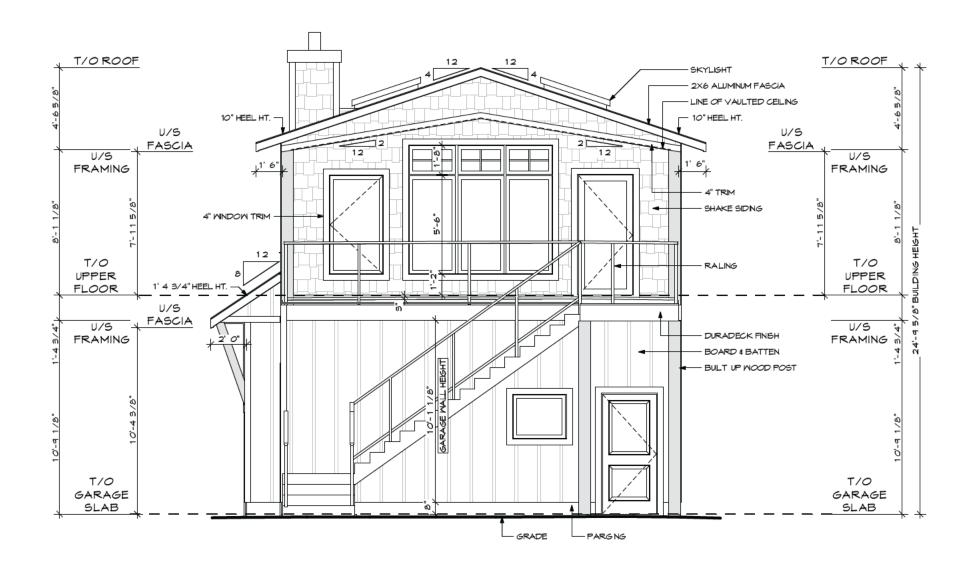




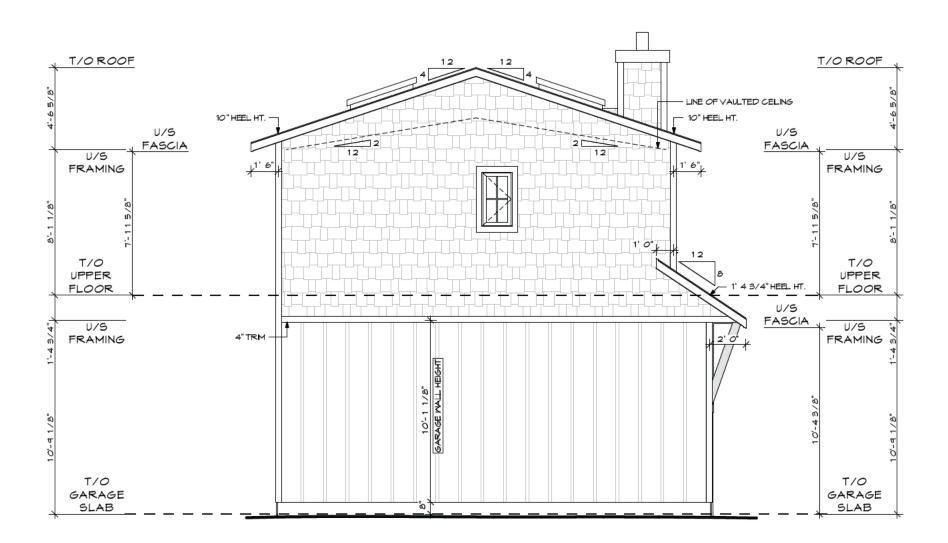
### ROOF PLAN

ALL DOWNSPOUT LOCATIONS
TO BE CONFIRMED WITH BUILDER
PRIOR TO INSTALLATION

ALL SPECIFICATIONS FOR THE NBC 20 19 (AE), 9.36. ENERGY CODE TO BE SUPPLIED BY OTHERS. DRAWINGS TO BE REVIEWED & APPROVED BY THE LOCAL MUNICIPALITY OR PERMITTING AUTHORITIES. LEGAL ADDRESS: CIVIC ADDRESS: CLIMATE ZONE: BUILDING AREA: AIRTIGHTNESS 163 BIRCHCLOFF RD, SV OF BIRCHCLIFF, AB LOT: 16, BLOCK: 2, PLAN: 4 112 EO ٦A 99 SQ M 2.5 PROJECT NAME: CLIENT CONTACT INFO: DRAFTED BY: PROJECT NUMBER: SCALE: MAIN FLOOR: 0000 SF UPPER FLOOR SUITE: 792 SF TOTAL: 0000 SF 163 BIRCHCLIFF RD 3/16" = 1'-0" GMS-2021-01 KAREN RICHINSKI DEV LOWER FLOOR: 0000 SF TOTAL LOWER FLOOR: 0000 SF TOTAL DEVELOPED: 0000 SF SHEET TITLE: DATE: SHEET: CELL: 403.396.0354 EMAIL: KAREN@KDRD.CA WEB: WWW.KDRD.CA KD RESIDENTIAL A05 **ROOF PLAN** GARAGE: 1068 SF 17-12-2021



# FRONT ELEVATION





ALL STRUCTURAL TIMBER

ALL DOWNSPOUT LOCATIONS

ALL GRADES TO BE



### LEFT SIDE ELEVATION

THE FACE & SIDES OF WALLS AND UNDERSIDE OF CANTILEVERS
WITHIN 1.2 M FROM PROPERTY LINE TO HAVE NON-COMBUSTIBLE
CLADDING TO ACHIEVE 45 MIN. FIRE RESISTANCE RATING.
-EITHER CEMENT BOARD CLADDING OR EXTERIOR
DRYWALL BENEATH VINYL SIDING TO BE INSTALLED

UNVENTED SOFFIT REQUIRED ON EAVES

CLOSER THAN 1.2 M TO PROPERTY LINE

C/W ADDITIONAL ROOF VENTING AS REQ'D

£ C

DRAFTED BY:

ALL STRUCTURAL TIMBER
MATERIAL TO BE SIZED
& CONFIRMED BY OTHERS

ALL DOWNSPOUT LOCATIONS
TO BE CONFIRMED WITH BUILDER
PRIOR TO INSTALLATION

ALL GRADES TO BE CONFIRMED BY OTHERS PRIOR TO CONSTRUCTION

ALL SPECIFICATIONS FOR THE NBC 20 19 (AE). 9.36. ENERGY CODE TO BE SUPPLIED BY OTHERS.

DRAMINGS TO BE REVIEWED & APPROVED BY THE LOCAL MUNICIPALITY OR PERMITTING AUTHORITIES. MAIN FLOOR: 0000 SF UPPER FLOOR SUITE: 792 SF TOTAL: 0000 SF

DEV LOMER FLOOR : 0000 SF TOTAL LOMER FLOOR : 0000 SF TOTAL DEVELOPED : 0000 SF

GARAGE: 1068 SF

CLIMATE ZONE:

BULDING AREA:

99 SQ M

AIRTIGHTNESS

2.5

LEGAL ADDRESS

LOT: 16, BLOCK: 2, PLAN: 4 112 EO

/IC ADDRESS:

163 BIRCHCLOFF RD, SV OF BIRCHCLIFF, AB CLIENT CONTACT INFO:

KAREN RICHINSKI
ARCHITECTURAL TECHNOLOGIST

CELL: 403.396.0354
EMAIL: KAREN®KDRD.CA
WEB: WWW.KDRD.CA

PROJECT NAME:
163 BIRCHCLIFF
RD

SHEET TITLE:

**ELEVATIONS** 

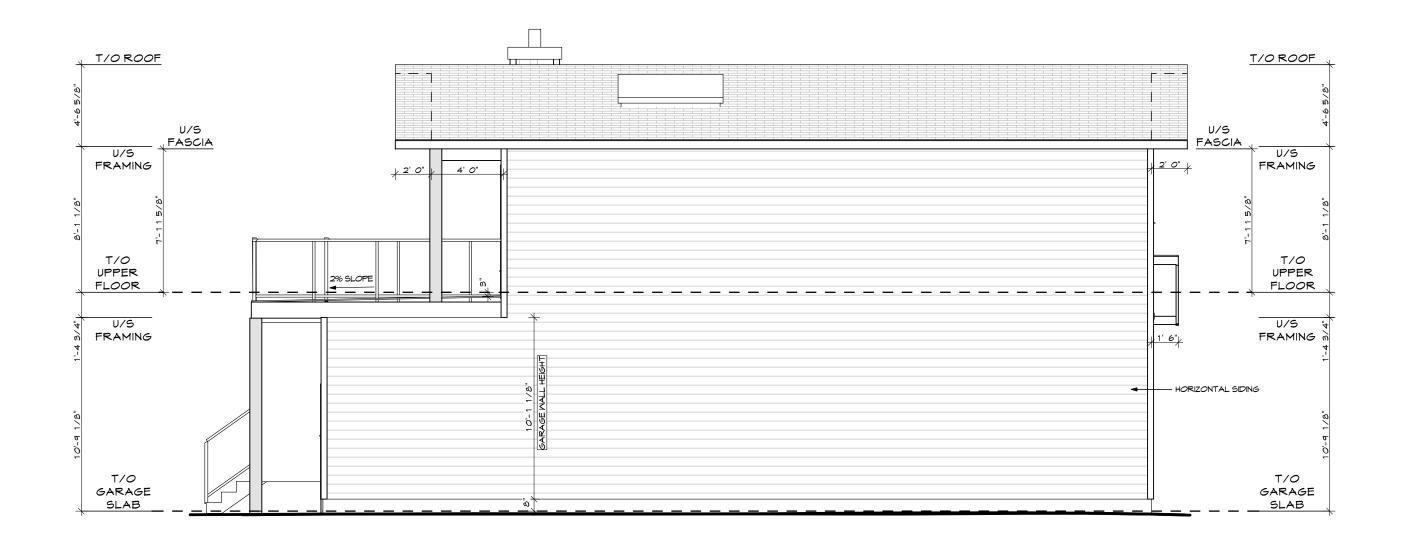
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1-01 3/16" = 1'-0"

SCALE:

17-12-2021 SHEET:



### RIGHT SIDE ELEVATION

THE FACE & SIDES OF WALLS AND UNDERSIDE OF CANTILEVERS WITHIN 1.2 M FROM PROPERTY LINE TO HAVE NON-COMBUSTIBLE CLADDING TO ACHIEVE 45 MIN. FIRE RESISTANCE RATING. -EITHER CEMENT BOARD CLADDING OR EXTERIOR DRYWALL BENEATH VINYL SIDING TO BE INSTALLED

UNVENTED SOFFIT REQUIRED ON EAVES CLOSER THAN 1.2 M TO PROPERTY LINE C/W ADDITIONAL ROOF VENTING AS REQ'D

DRAFTED BY:

ALL STRUCTURAL TIMBER MATERIAL TO BE SIZED & CONFIRMED BY OTHERS

ALL DOWNSPOUT LOCATIONS TO BE CONFIRMED WITH BUILDER PRIOR TO INSTALLATION

ALL GRADES TO BE CONFIRMED BY OTHERS PRIOR TO CONSTRUCTION

ALL SPECIFICATIONS FOR THE NBC 20 19 (AE), 9.36. ENERGY CODE TO BE SUPPLIED BY OTHERS.

DRAWINGS TO BE REVIEWED & APPROVED BY THE LOCAL MUNICIPALITY OR PERMITTING AUTHORITIES.

MAIN FLOOR: 0000 SF UPPER FLOOR SUITE: 792 SF TOTAL: 0000 SF

DEV LOWER FLOOR: 0000 SF TOTAL LOWER FLOOR: 0000 SF TOTAL DEVELOPED: 0000 SF GARAGE: 1068 SF

TΑ BUILDING AREA 99 SQ M AIRTIGHTNESS 2.5

CLIMATE ZONE: LEGAL ADDRESS:

LOT: 16, BLOCK: 2, PLAN: 4 112 EO

CIVIC ADDRESS:

163 BIRCHCLOFF RD, SV OF BIRCHCLIFF, AB



CLIENT CONTACT INFO:

KAREN RICHINSKI CELL: 403.396.0354 EMAIL: KAREN@KDRD.CA WEB: WWW.KDRD.CA KD RESIDENTIAL

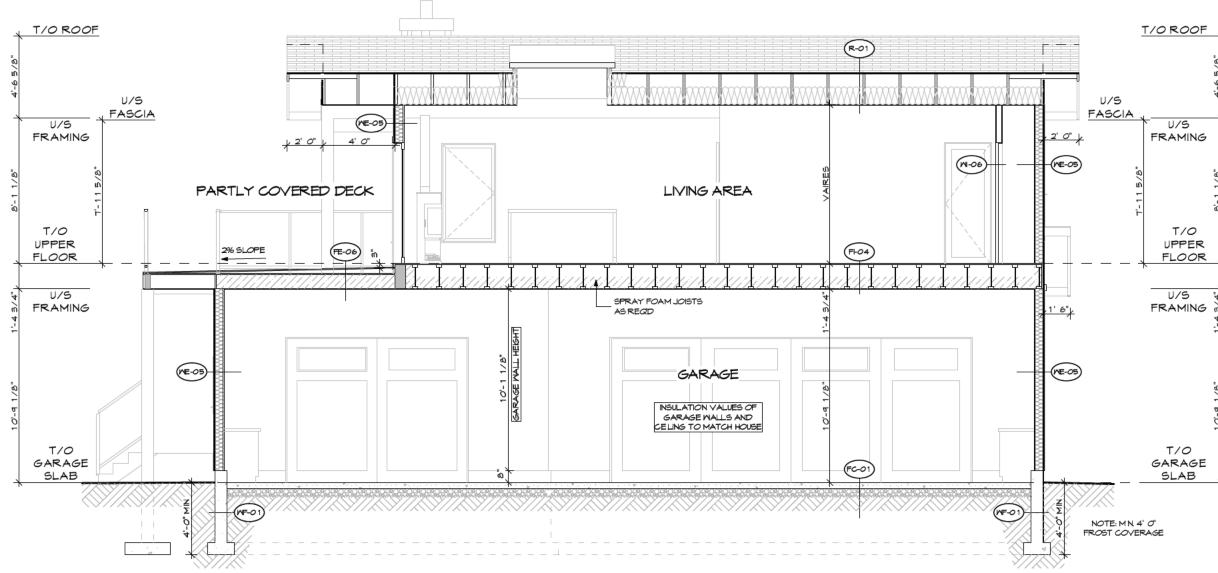
PROJECT NAME: 163 BIRCHCLIFF RD SHEET TITLE:

**ELEVATIONS** 

PROJECT NUMBER: GMS-2021-01

SCALE: 3/16" = 1'-0"

A08 17-12-2021



### BUILDING SECTION A

# CONSTRUCTION ASSEMBLIES (AS PER NBC 2019 (AE))

#### MALL ASSEMBLIES

WF-01 8"FROST WALL (GARAGE)

8"CONCRETE FOUNDATION WALL (9.15.4) DAMPPROOFING (BELOW FINISHED GRADE)(9.13.2) PARGING (ABOVE FINISHED GRADE)

WF-02 FROST WALL ASSEMBLY (WALK-OUT/CRAWL SPACE)

RIGID INSULATION (9.36.2.8) 8"CONCRETE FOUNDATION WALL (9.15.4) DAMPPROOFING (BELOW FINISHED GRADE) (9.13.2)

WF-03 CONCRETE FOUNDATION WALL ASSEMBLY

1/2" GYPSUM BOARD MALL FINISH UNLESS NOTED OTHERMISE 6 ML POLY VAPOR BARRIER (9.25.4) NSILLATION (9 36 2 8)

2X4 KD. SPRUCE/PINE STUDS (SPACING BY OTHERS)
1" AIR SPACE
8" CONCRETE FOUNDATION WALL (9.15.4)

DAMPPROOFING (BELOW FINISHED GRADE)(9.13.2) PARGING (ABOVE FINISHED GRADE) WF-04 CONCRETE FOUNDATION WALL ASSEMBLY w / FINISH

1/2"GYPSUM BOARD WALL FINISH UNLESS NOTED OTHERWISE 6 MIL POLY VAPOR BARRIER (4.25.4) INSULATION (4.36.2.6) 2x4 K.D. SPRUCE/PINE STUDS (SPACING BY OTHERS) 1"AIR SPACE 6"CONCRETE FOUNDATION WALL (4.15.4) 3/8"OSB SHEATHING (4.23.17) PERMEABLE BUILDING PAPER (4.36.2.10)

ME-05 EXTERIOR MALL ASSEMBLY

FINISH AS SPECIFIED

FINISH AS SPECIFIED

1/2"GYPSUM BOARD WALL FINISH UNLESS NOTED OTHERWISE 6 MIL POLY VAPOR BARRIER (9.25.4) INSULATION (4.36.2.6)

2x6 K.D. SPRUCE /PINE STUDS (SPACING BY OTHERS) (P.T. MATERIAL BELOW GRADE) 3/8" OSB SHEATHING (9.23.17) PERMEABLE BUILDING PAPER (9.36.2.10)

WI-06 INTERIOR PARTITION WALL ASSEMBLY

1/2"GYPSUM BOARD WALL FINISH UNLESS NOTED OTHERWISE (MOISTURE RESISTANT GYPSUM IN BATHROOMS - WONDER BOARD IN SHOWERS) 2X4 K.D. SPRUCE / PINE STUDS (SPACING BY OTHERS) (UNLESS NOTED OTHERWISE) ACOUSTICAL INSULATION (WHERE APPLICABLE) 1/2"GYPSUM BOARD WALL FINISH UNLESS NOTED OTHERWISE WI-01 INTERIOR PARTITION WALL ASSEMBLY GARAGE/HOUSE (2x6) LOAD BEARING

1/2" GYPSUM BOARD WALL FINISH UNLESS NOTED OTHERWISE
(MOISTURE RESISTANT GYPSUM IN BATHROOMS - WONDER BOARD IN TILED SHOWERS)
6 MIL POLY VAPOUR BARRIER (9.25.4)
INSULATION (9.36.26)
2X6 K.D. SPRUCE / PINE STUDS (SPACING BY OTHERS)
1/2" GYPSUM BOARD WALL FINISH FIRE-TAPED AS REQ'D FOR FUME BARRIER

#### FLOOR ASSEMBLIES

FC-01 GARAGE SLAB ASSEMBLY (4")

4" CONCRETE SLAB - REINFORCED AS PER STRUCTURAL REQ 4 SLOPED AS SPECIFIED 6 MIL POLY VAPOUR BARRIER (9.25.4) 4" MIN. MASHED ROCK (9.16.2.1) UNDISTURBED SOIL

FC-02 BASEMENT ASSEMBLY (3 1/2")

3 1/2" CONCRETE SLAB - REINFORCED AS PER STRUCTURAL REQ. 6 MIL POLY VAPOUR BARRIER (9.25.4) INSULATION (IF REQ'D) (9.36.2.6) 4" MIN, WASHED ROCK (9.16.2.1) UNDISTURBED SOIL FI-03 RESIDENCE FLOOR ASSEMBLY (ABOVE GRADE)

FINISHED FLOOR AS SPECIFIED
3/4"T46 EXTERIOR GRADE SHEATHING (9.23.15)
(OPT. BUILT-UP SHEATHING FOR FINISHED FLOOR SELECTIONS)
TJI FLOOR SYSTEM - ENSINEERED BY OTHERS
ACOUSTICAL INSULATION (NHERE APPLICABLE)
INSULATION & JOIST ENDS & CANTILEVERED AREAS)(9.36.2.6)
CROSS BRACING AS REQU'D
1/2" SYPSUM BOARD (INTERIOR FINISHED SPACE)
FINISH AS SPECIFIED (INTERIOR SPACE)
SOFFIT (CANTILEVERED FLOOR AREAS)

FI-04 RESIDENCE FLOOR ASSEMBLY OVER GARAGE

FINISHED FLOOR AS SPECIFIED
3/4" T46 EXTERIOR GRADE SHEATHING (9.23.15)
(OPT. BUILT-UP SHEATHING FOR FINISHED FLOOR SELECTIONS)
TJI FLOOR SYSTEM - ENGINEERED BY OTHERS
CROSS BRACING AS REQD
6 MI POLY VAPOUR BARRIER (9.25.4)
STRAPPING AS REQ'D BELOW JOISTS FOR INSULATION
INSULATION (9.36.2.6)
1/2" GYPSUM BOARD FIRE-TAPED AS REQ'D FOR FUME BARRIER

FE-05 EXTERIOR DECK ASSEMBLY

FINISH AS SPECIFIED

EXTERIOR GRADE WOOD DECKING WOOD JOISTS - AS PER STRUCTURAL REQ.

#### FE-06 EXTERIOR DECK ASSEMBLY OPTION B

MATERPROOF MEMBRANE
3/4" T46 EXTERIOR GRADE SHEATHING (SLOPED)
FRAMING AS REQD FOR SLOPE
MOOD JOISTS - AS PER STRUCTURAL REQ.
CROSS BRACING AS REQD
INSULATION (IF REQD) (4.36.26)
VENTED SOFFIT (EXTERIOR AREAS)
FINISH AS SPECIFIED (INTERIOR SPACE)
1/2" GYPSUM BOARD FIRE-TAPED AS REQD FOR
FUME BARRIER (GARAGE SPACE)

FE-07 PATIO SLAB ASSEMBLY

4" CONCRETE SLAB - REINFORCED AS PER STRUCTURAL DRAWINGS 6 MIL POLY VAPOUR BARRIER (9.25.4) 4" MIN. MASHED ROCK (9.16.2.1) INDISTURED SOIL

#### ROOF ASSEMBLIES

R-01 ROOF ASSEMBLY - SLOPED

FINISHED ROOFING AS SPECIFIED EAVE PROTECTION (9.26.10)
7/16" OSB SHEATHING C/W H CLIPS (9.23.16)
PRE-ENGINEERED ROOF JOISTS / TRUSSES (ENGINEERED BY OTHERS)
INSULATION (ABOVE LIVING SPACE)(4.36.26)
6 MIL POLY VAPOUR BARRIER (ABOVE LIVING SPACE)(9.25.4)
1/2" GYPSUM BOARD
VENTED SOFFIT & EAVES (UNVENTED AS PER 3.2.3.6)

ALL SPECIFICATIONS FOR THE NBC 2019 (AE), 9.36. ENERGY CODE TO BE SUPPLIED BY OTHERS.

DRAWINGS TO BE REVEWED & APPROVED BY THE LOCAL MUNICIPALITY OR PERMITTING AUTHORITIES. MAIN FLOOR : 0000 SF UPPER FLOOR SUITE : 792 SF TOTAL : 0000 SF

DEV LOWER FLOOR: 0000 SF TOTAL LOWER FLOOR: 0000 SF TOTAL DEVELOPED: 0000 SF

GARAGE: 1068 SF

CLIMATE ZONE:

BULDING AREA:
99 SQ M

AIRTIGHTNESS

2.5

LOT: 16, BLOCK: 2, PLAN: 4 112 EO

163 BIRCHCLOFF RD, SV OF

CLENT CONTACT INFO:



DRAFTED BY:



KAREN RICHINSKI

CELL: 403.396.0354 EMAIL: KAREN@KDRD.CA WEB: WWW.KDRD.CA PROJECT NAME: 163 BIRCHCLIFF RD

GM5-2021-01

PROJECT NUMBER

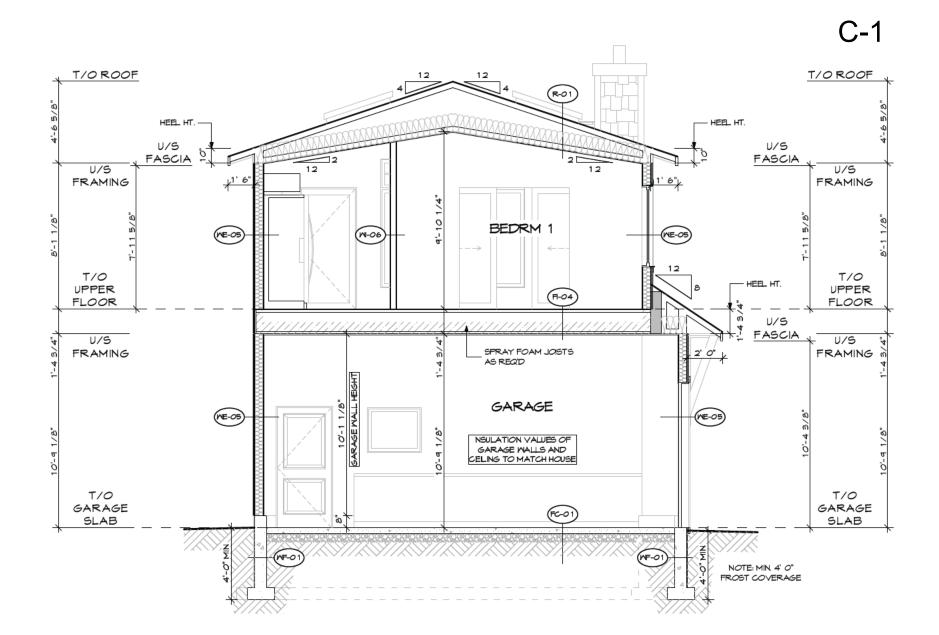
3/16" = 1'-0"

SHEET TITLE: DATE:

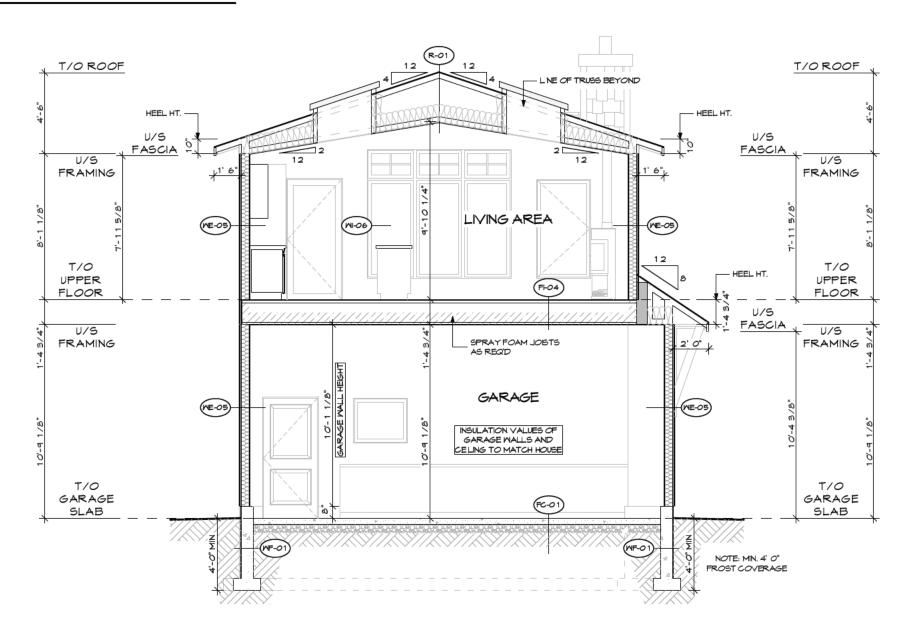
BUILDING
SECTIONS 17-12-2021

SHEET: **A0**9

SCALE:

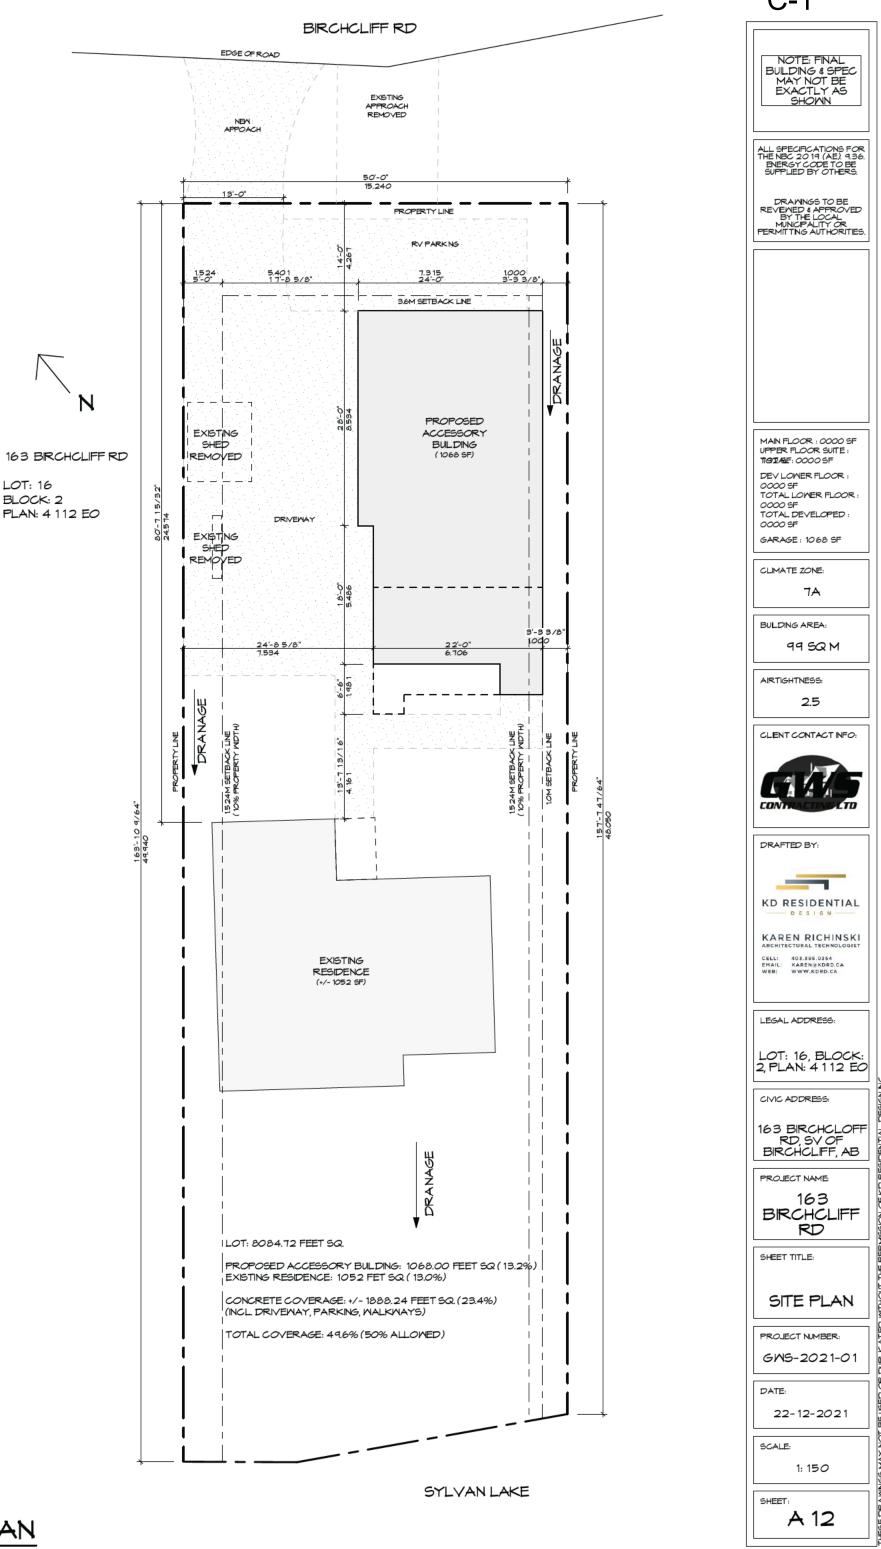


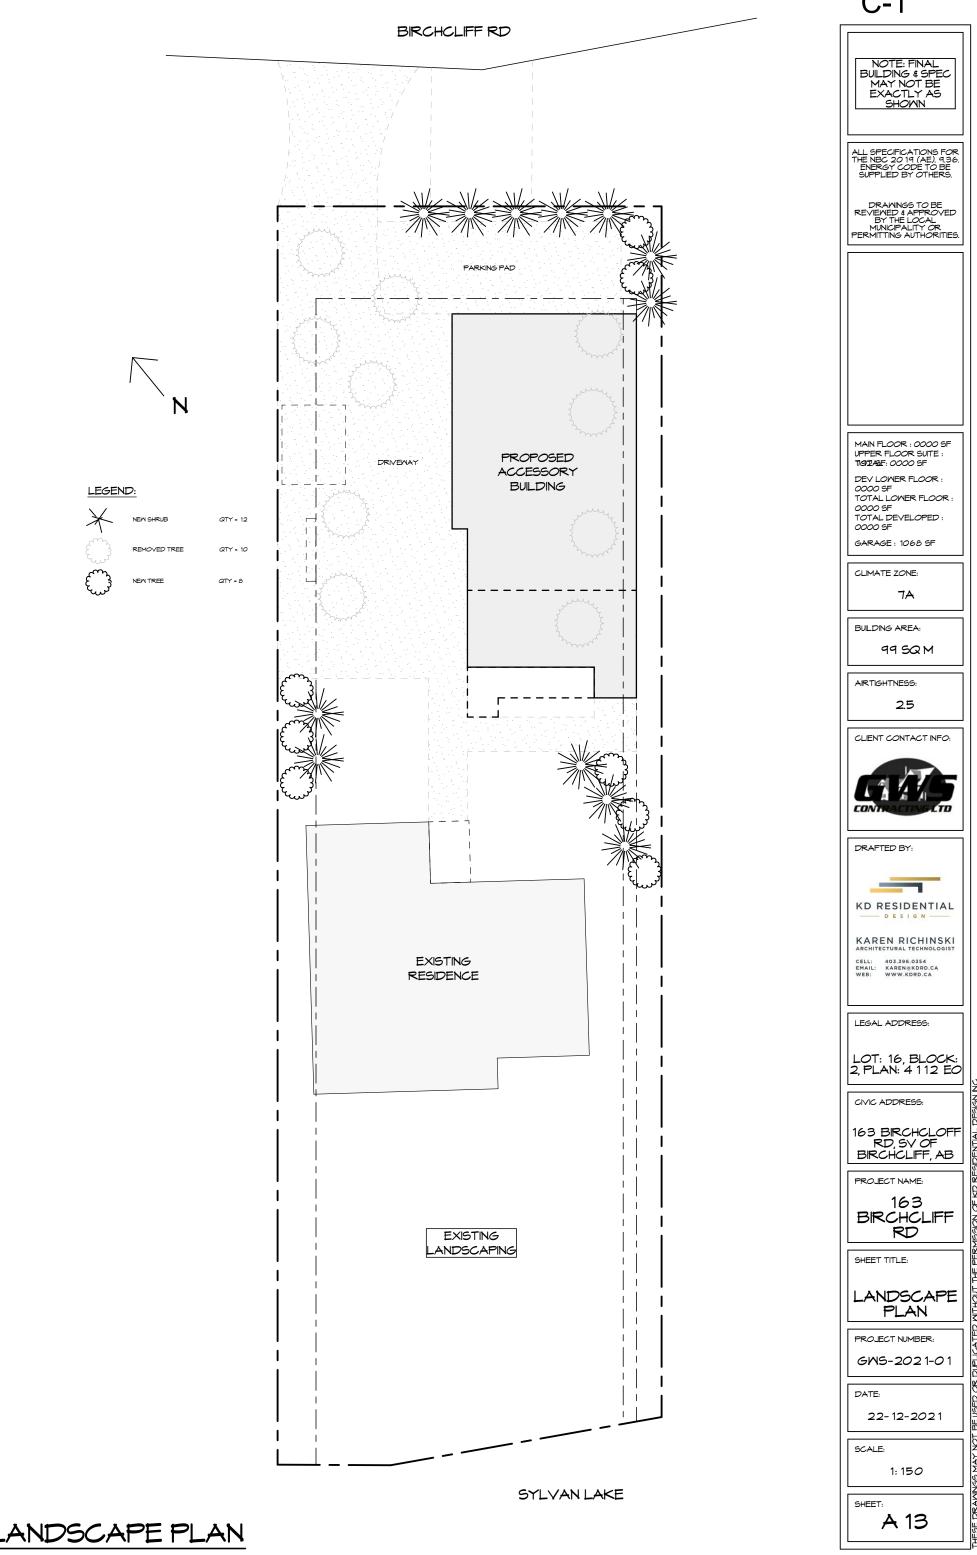
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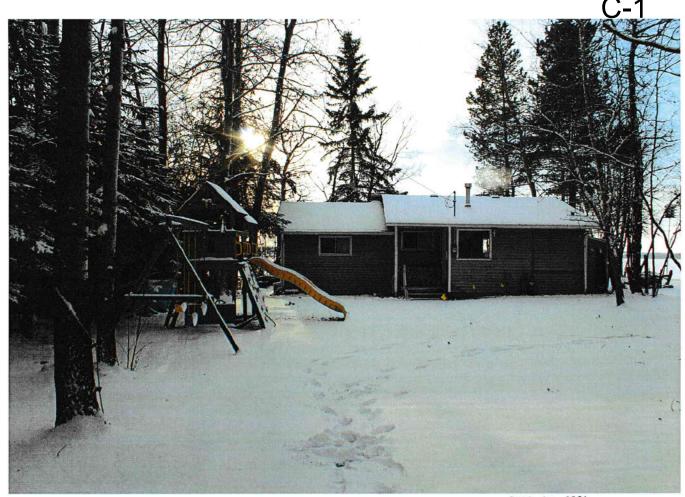


# BUILDING SECTION C

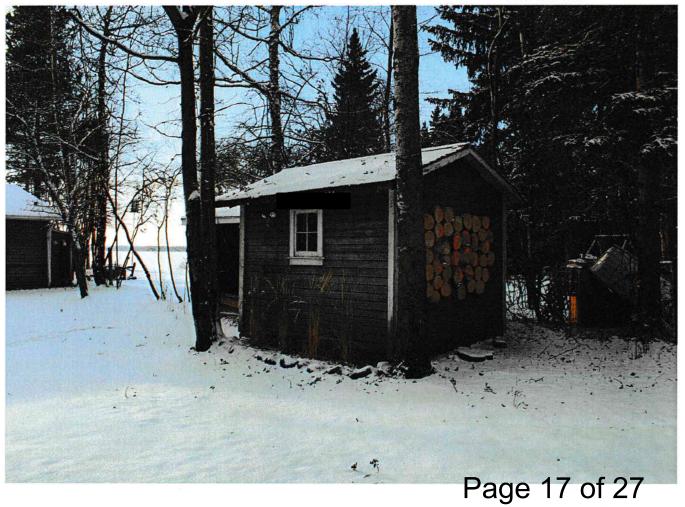


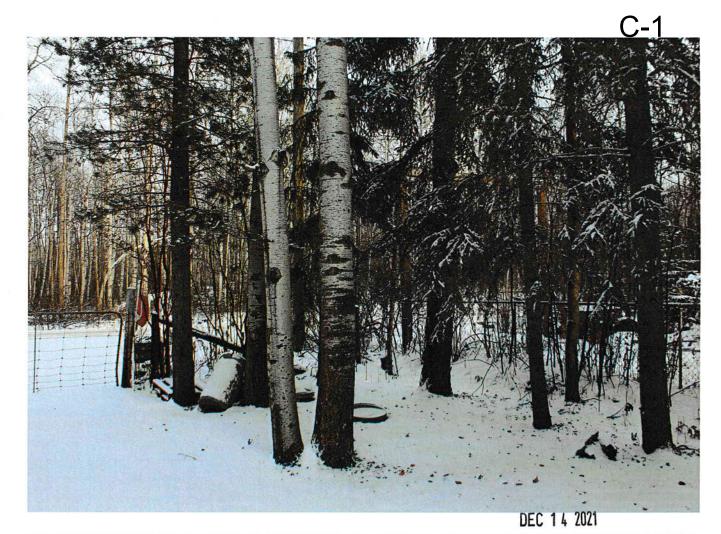


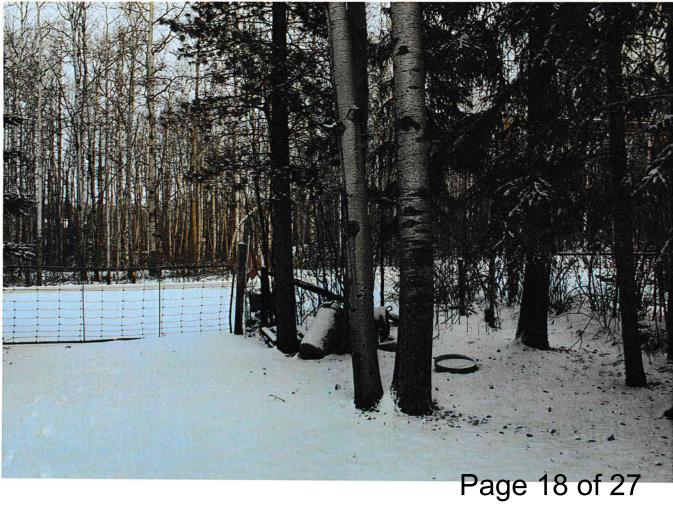




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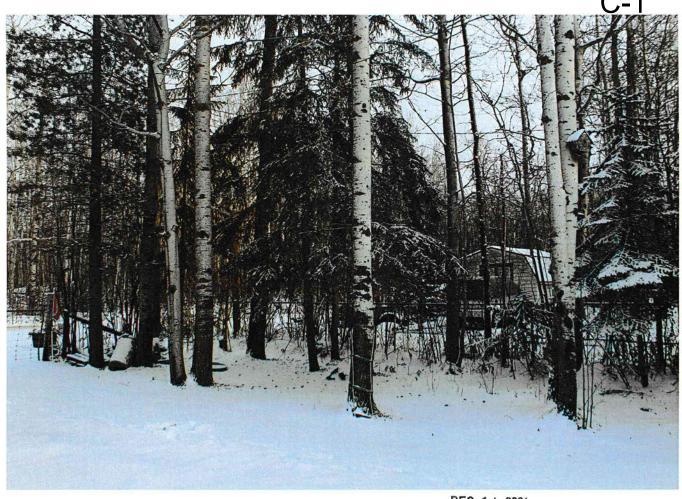


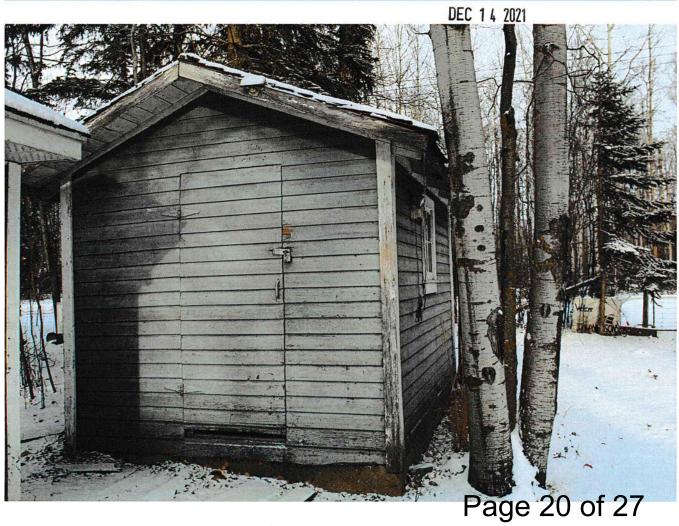


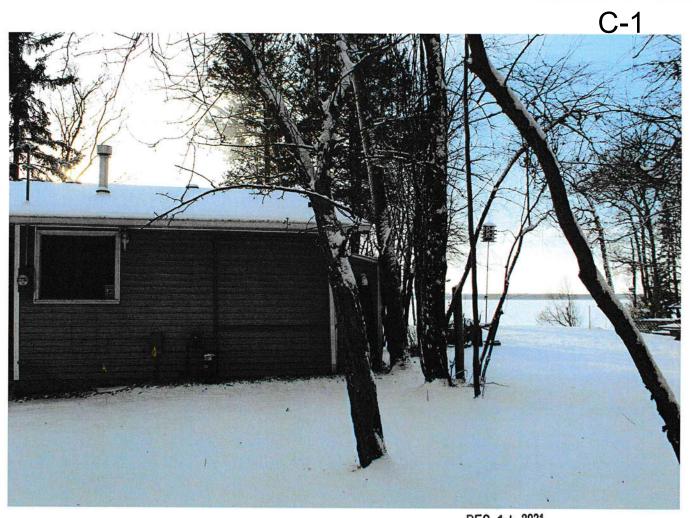


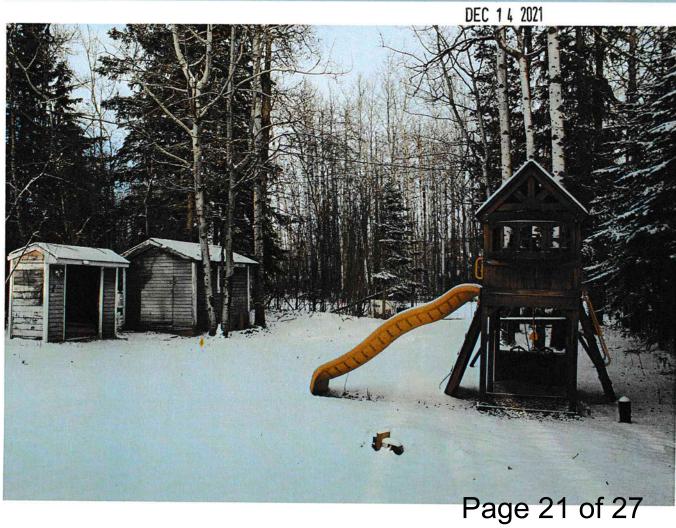


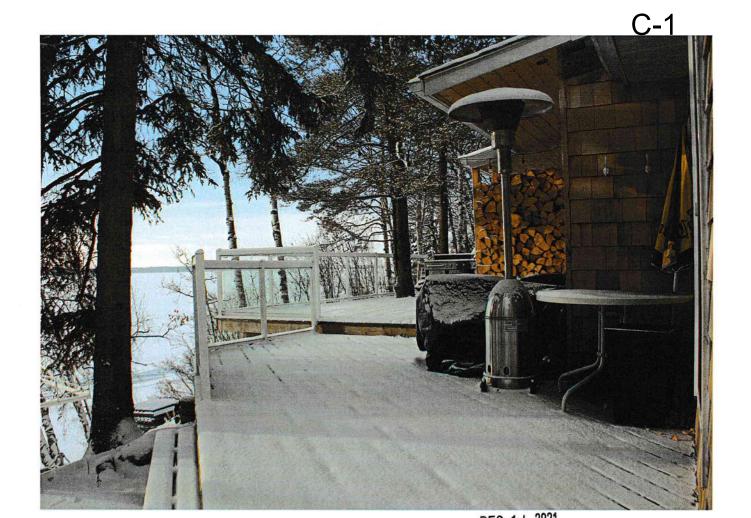




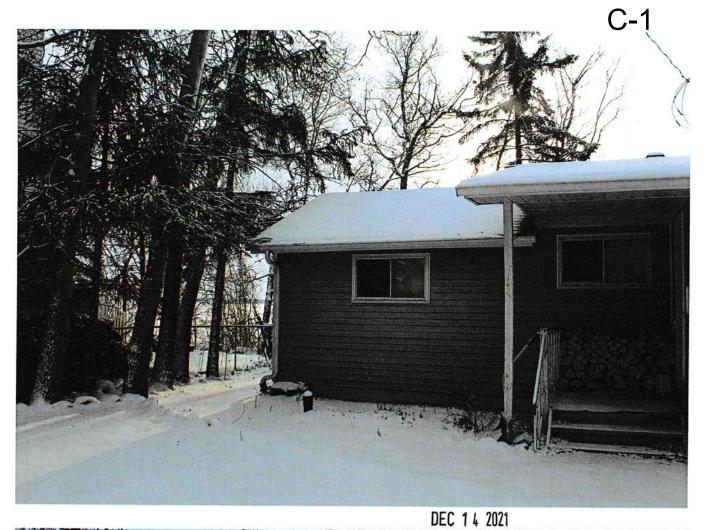


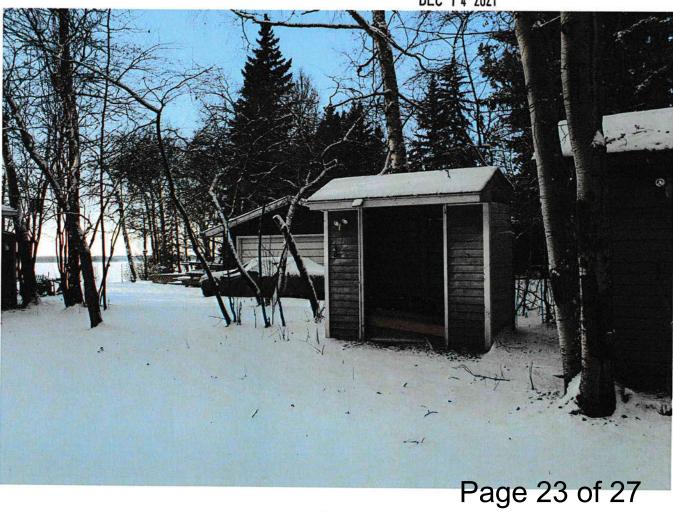


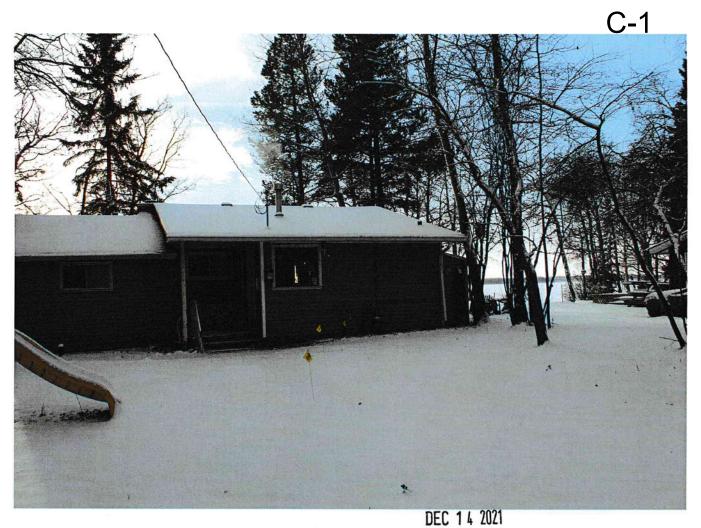


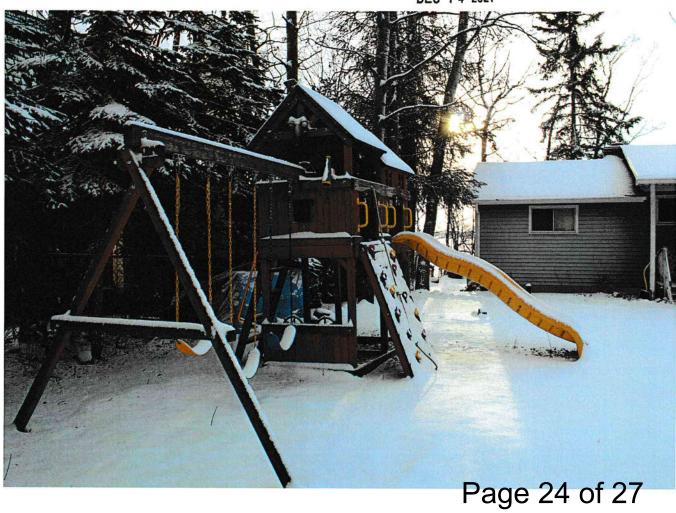


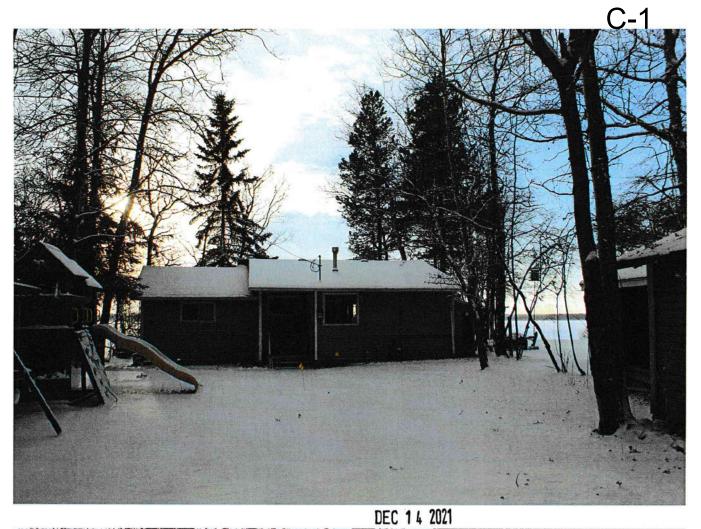


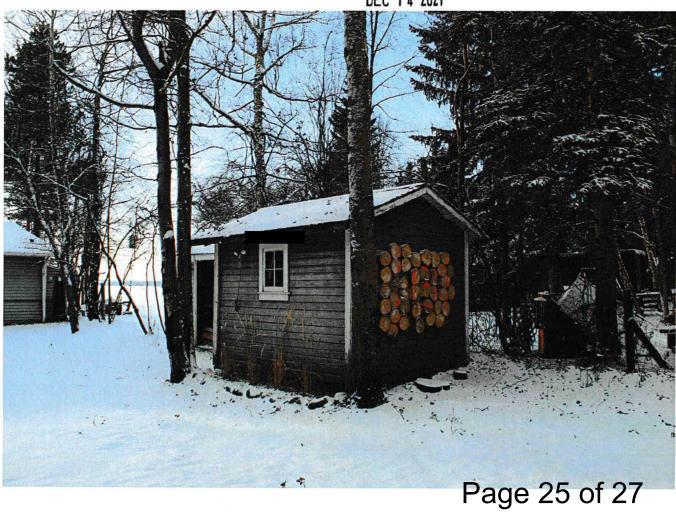












# Google Maps

163 Birchcliff Rd

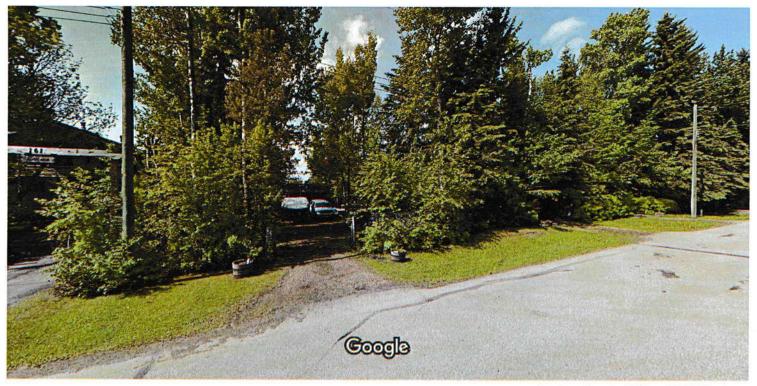


Image capture: Jun 2014

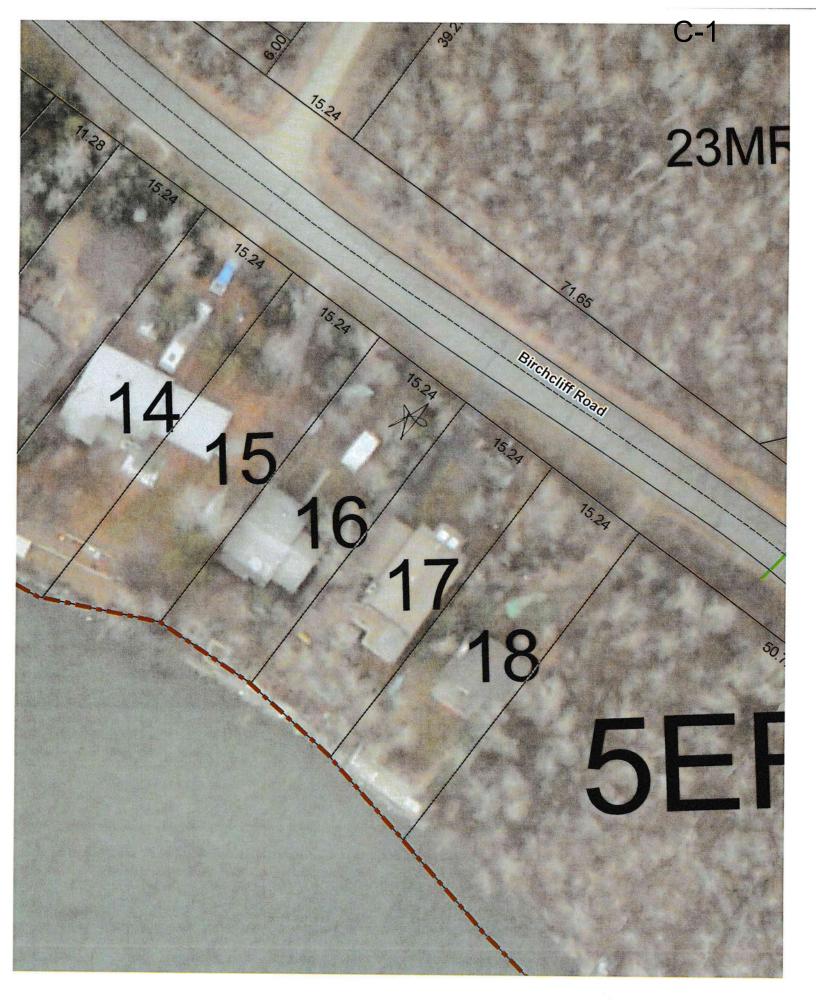
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Street View - Jun 2014





Page 27 of 27